NOTICE

NO HAND CARRIED BIDS! NO MAILED BIDS!

Current security requirements established by the U.S. Capitol Police to screen mail being delivered to the U.S. Capitol Complex of buildings preclude the use of U.S. Postal Service by offerors to deliver their proposals submitted in response to this solicitation. In addition, because all packages must be screened for security purposes at a central location prior to their delivery, the Architect of the Capitol cannot accept packages containing offers handcarried directly to the Bid Room address within the Ford House Office Building, as specified elsewhere in this solicitation, or at any other location in the U.S. Capitol Complex of buildings.

Due to these unusual circumstances the Procurement Division for the Architect of the Capitol will only accept offers/proposals via UPS or FEDEX. See provision AOC52.215-1 Instructions to Offerors located in Section L for solicitations for services/supplies or the Solicitation Conditions for solicitations for construction. A11 handcarried offers/proposals will be rejected. Any attempt to handcarry an offer/proposal to any location in the U.S. Capitol Complex of buildings will be refused. Offerors are advised when sending proposals via FEDEX or UPS not to use same day delivery. FEDEX/UPS often subcontract out the delivery for same-day service. It is necessary for delivery personnel to arrive in a FEDEX/UPS truck and be in a uniform recognized as FEDEX/UPS. Offerors are encouraged to determine who will be making the delivery when making arrangements with FEDEX/UPS.

NOTICE TO CONTRACTORS

The Architect of the Capitol anticipates that in 2006 the agency's contractors will have to register with the Central Contractor Registration (CCR) database. This is the primary vendor database for the U.S. Federal Government and the CCR collects, validates, stores, and disseminates data in support of agency acquisition missions.

Registration in the CCR will become mandatory in order to be awarded contracts by the Federal Government. Vendors are required to complete a one-time registration to provide basic information relevant to procurement and financial transactions. Vendors must update or renew their registration at least once per year to maintain an active status.

CCR validates the vendor information and electronically shares the secure and encrypted data with the federal agencies finance offices to facilitate paperless payments through electronic funds transfer (EFT).

The AOC is now encouraging all vendors to register with the CCR if they are not already registered. Vendors can register on line at http://www.ccr.gov. This internet site contains all pertinent information for registration as well as provides contact points for help when registering.

soi		TION, OFFER AND AW tect of the Capitol - January 2004	ARD R	EQUISITION NO.						PROJECT NO.	F	PAGE OF	53	PAGES
1. CO	ONTRACT 1	NO.	2.	SOLICITATION N	10.	3		SEALEI	LICITATION D BID (IFB) TIATED (RFP)		4. DATE ISSUED August 29, 2006			
5. ISS	SUED BY	ARCHITECT OF THE CAPITO United States Capitol Washington, D.C. 20515)L			6	Archite Ford H Room	ect of the Ca ouse Office	R TO (If other than Item : upitol, Procurement Divi Building, Attn: (JOHN Room, Second and "D"	sion FRIEDHOFF)				
NOTE	: In sealed	bid solicitations "offer" and "offere	r" mean "bid"	and "bidder".										
SUBJ	ECT: FAE	BRICATION OF MEMBER IDEN	TFICATION A	ND STATE SEAL	INTERIO	OR WAY	FINDIN	G SIGN AC	SE FOR THE SENATE O	FFICE BUILDING	SS, WAS	HINGTON	DC.	
SOLICITATION 7. Sealed offers in original and 3complete copies for furnishing the supplies or services in the Schedule will be received at the place specified in Item 6 until 2:00 P.M., local time, October 3, 2006. A pre-proposal conference is scheduled for September 14, 2006 at 2:00 PM local time. CAUTION - Submission, Modification, Revision, and Withdrawal of Offers: See Section L. All offers are subject to all terms and conditions contained in this solicitation.														
8. FO	R INFORM	ATION CALL: John Fried	hoff	TELEPHONE					CT CALLS) (202) 22	26-4525				
(x)	SEC.	DESCR	PTION			ABLE OF	(x)	SEC.	1	DESCRIPTION			P	AGE(S)
		PART 1 - THE				(-)				CONTRACT CLA	USES			- (-)
X	A	SOLICITATION/CONTRACT F	ORM		1	A	X	I	CONTRACT CLAUSE	S				17
X	В	SUPPLIES OR SERVICES AND	PRICES/COS	STS	1	1		1	PART III - LIST OF DOC	UMENTS, EXHII	BITS AN	D OTHER A	ATTACE	· I.
	С	DESCRIPTION/SPECS./WORK	STATEMEN	Γ			Х	J	LIST OF ATTACHME	NTS				1
X	D	PACKAGING AND MARKING				2			PART IV - REPRESENTATIONS AND INS			ATIONS AND INSTRUCTIONS		
X	E	INSPECTION AND ACCEPTA	NCE			1			REPRESENTATIONS, CERTIFICATIONS AND					
X	F	DELIVERIES OR PERFORMA	NCE			1	Х	K	OTHER STATEMENTS OF OFFERORS 6			6		
X	G	CONTRACT ADMINISTRATIO	N DATA			2	X L INSTRS., CONDS., AND NOTICES TO OFFERORS 4				4			
	Н	SPECIAL CONTRACT REQUIR	EMENTS				X M EVALUATION FACTORS FOR AWARD 4				4			
					1	-	, ,	eted by offe	eror)					
		does not apply if the solicitation in							1:ss	: - J :- :	d) from the	data for	
		with the above, the undersigned as pecified above, to furnish any or all												
11. DI	ISCOUNT F	OR PROMPT PAYMENT	10 CA	LENDAR DAYS		20 CAL	ENDAR	DAYS %	30 CALENDAR DA	AYS %		CALEN	DAR DA	AYS %
12. A	CKNOWLE	DGMENT OF	AMEN	DMENT NO.			DATE		AMENDME	NT NO.		DA	TE	
receip	nt of amendn	(The offeror acknowled ges nents to the SOLICITATION												
for off and d		elated documents numbered												
	NAME AND ADDRESS OF OFFEROR	DUNS NOTAXPAYER IDENTIFIC	ATION NO						14. NAME AND TITL (Type or Print)	E OF PERSON A	UTHOR	IZED TO S	IGN OF	FER
13B.	TELEP HON	IE & FACSIMILE NOS. (Include codes)	area		NT FRO	M ABOV	CE ADDRESS IS 15. SIGNATURE BOVE -ENTER CHEDULE 16. OFFER DATE				ATE			
					ARD	(To be con		y Governm						
17. A	CCEPTED	AS TO ITEMS NUMBERED	18. AMO	UNT			19. A	CCOUNTIN	NG AND APPROPRIATION	ON				
20. AUTHORITY FOR NEGOTIATION, IF APPLICABLE 21. SUBMIT INVOICE FOR PAYMENT TO: ACCT. FAX 202-226-2580														
22. NAME OF CONTRACTING OFFICER (Type or print) 23. U					ATES OF AMERICA	(ff.ggv)	2	4. AWARI	D DATE					
(Signature of Contracting Officer)														

SECTION B

THE SCHEDULE: SUPPLIES OR SERVICES AND PRICES/COSTS

The Contractor shall furnish all materials, labor and equipment necessary for the fabrication of Interior Way-finding Signs for the Members of Congress office suites, as required by the Architect of the Capitol, located in Washington, DC in accordance with the terms and conditions, specifications and drawings all shown in this solicitation. As a separate line item all, or some of these signs may require installation by the contractor. All contractors are required to submit a price on all line items for the base year with total, and clearly show prices for each option year with totals.

1. SCHEDULE OF ITEMS:

BASE PERIOD Oct. 2006 to Oct. 2007 (Estimated)

Item No.	Description	Estimated Quantity	<u>Unit</u>	TT/N/I	Amount
<u>No.</u>	<u>Description</u>	Quantity	<u>Price</u>	<u>U/M</u>	Amount
0001AA	Sign Type A - Floor Level Identification	<u>47</u>	\$	<u>EA</u>	\$
0001AB	Installation of Sign Type A	<u>47</u>	\$	<u>EA</u>	\$
					·
0001AC	Installation of Sign Type B.0	<u>10</u>	\$	$\mathbf{\underline{EA}}$	\$
0001AD	Installation of Sign Type B.1	<u>7</u>	\$	<u>EA</u>	\$
0001AE	Installation of Sign Type D, V, W	<u>55</u>	\$	<u>EA</u>	\$
0001AF	Sign Type B.0 - Room # Identification	<u>10</u>	\$	<u>EA</u>	\$
0001AG	Sign Type B.1 Room Description	<u>7</u>	\$	<u>EA</u>	\$
0001AH	Sign Type D - Destinations Directory	<u>36</u>	\$	<u>EA</u>	\$
0001AI	Sign Type E - Exit Directory (within elevator)	<u>24</u>	\$	<u>EA</u>	\$
	,				
0001AJ	Installation of Sign Type E	2 <u>4</u>	\$	<u>EA</u>	\$
0001AK	Sign Type F - Floor Directory	<u>80</u>	\$	<u>EA</u>	\$
0001AL	Installation of Sign Type F	<u>80</u>	\$	<u>EA</u>	\$
0001AM	Sign Type G - Secondary Directional	<u>100</u>	\$	<u>EA</u>	\$
0001AN	Installation of Sign Type G, G.1, K	<u>120</u>	\$	<u>EA</u>	\$
0001AP	Sign Type G.1 - Plaque	<u>28</u>	\$	<u>EA</u>	\$

Item <u>No.</u>	Description	Estimated Quantity	<u>Unit</u> Price	U/M	Amount
0001AQ	Sign Type GG - Bldg. Announcement Directory	<u>7</u>	\$	<u>EA</u>	\$
0001AR	Installation of Sign Type GG	<u>7</u>	\$	<u>EA</u>	\$
	G 11			<u> </u>	·
0001AS	Sign Type H - Identification Blade	<u>94</u>	\$	<u>EA</u>	\$
0001AT	Installation of Sign Type H, H.1, and I	<u>100</u>	\$	<u>EA</u>	\$
0001AU	Sign Type H.1 - Identification & Directional	<u>24</u>	\$	<u>EA</u>	\$
0001AV	Blade Graphic Plaque Sign Type HH -Exit Info.	<u>5</u>	\$	<u>EA</u>	\$
0001AW	Sign Type I - Directional Blade Graphic	<u>17</u>	\$	<u>EA</u>	\$
0001AX	Installation of Sign Type I	<u>17</u>	\$	<u>EA</u>	\$
0001AY	Sign Type K - Stair Level Identification	<u>25</u>	\$	<u>EA</u>	\$
0001AZ	Sign Type L - Restroom Plaque	<u>150</u>	\$	<u>EA</u>	\$
0001BA	Installation of Sign Type L, M, and HH	<u>160</u>	\$	<u>EA</u>	\$
0001BB	Sign Type M - Accessible Restroom	<u>17</u>	\$	<u>EA</u>	\$
0001BC	Sign Type S - Amenity Identification	<u>17</u>	\$	<u>EA</u>	\$
0001BD	Installation of Sign Type S	<u>17</u>	\$	<u>EA</u>	\$
0001BE	Sign Type T - Self Schedule Conf. Rm.	<u>17</u>	\$	<u>EA</u>	\$
0001BF	Installation of Sign Type T	<u>17</u>	\$	<u>EA</u>	\$
0002BG	Sign Type V - Handicap Restriction	<u>10</u>	\$	EA	\$
0001BH	Sign Type W - Hours of Operation	<u>25</u>	\$	<u>EA</u>	\$
	Total of Extended Unit Prices (Amounts) for 0001BH for the Base Period.	or Items No. (0001AA thr	ough	\$

OPTION PERIOD I Oct. 2007 to Oct. 2008 (Estimated)

Item No.	Description	Estimated Opentity	<u>Unit</u> Price**	U/M	Amount
<u>No.</u>	<u>Description</u>	Quantity			<u>Amount</u>
0002AA	Sign Type A - Floor Level Identification	<u>27</u>	\$	<u>EA</u>	\$
000017	T				
0002AB	Installation of Sign Type A	<u>27</u>	\$	<u>EA</u>	\$
0002AC	Installation of Sign Type B.0	<u>6</u>	\$	<u>EA</u>	\$
0002AD	Installation of Sign Type B.1	<u>4</u>	\$	<u>EA</u>	\$
0002AE	Installation of Sign Type D, V, W	<u>30</u>	\$	<u>EA</u>	\$
0002AF	Sign Type B.0 - Room # Identification	<u>6</u>	\$	<u>EA</u>	\$
0002AG	Sign Type B.1 Room Description	<u>4</u>	\$	<u>EA</u>	\$
0002AH	Sign Type D - Destinations Directory	<u>21</u>	\$	<u>EA</u>	\$
0002AI	Sign Type E - Exit Directory (within elevator)	<u>14</u>	\$	<u>EA</u>	\$
0002AJ	Installation of Sign Type E	1 <u>4</u>	\$	<u>EA</u>	\$
0002AK	Sign Type F - Floor Directory	4 <u>6</u>	\$	EA	\$ \$
0002AL	Installation of Sign Type F	<u> 46</u>	\$	EA	\$ \$
	G VI		·		
0002AM	Sign Type G - Secondary Directional	<u>77</u>	\$	<u>EA</u>	\$
0002AN	Installation of Sign Type G, G.1, K	<u>80</u>	\$	<u>EA</u>	\$
0002AP	Sign Type G.1 - Plaque	<u>12</u>	\$	<u>EA</u>	\$
0002AQ	Sign Type GG - Bldg. Announcement Directory	<u>4</u>	\$	<u>EA</u>	\$
0002AR	Installation of Sign Type GG	<u>4</u>	\$	<u>EA</u>	\$
0002AS	Sign Type H - Identification Blade	<u>54</u>	\$	<u>EA</u>	\$
0002AT	Installation of Sign Type H, H.1, and I	<u>60</u>	\$	<u>EA</u>	\$

Item <u>No.</u>	Description	Estimated Quantity	<u>Unit</u> <u>Price</u> **	<u>U/M</u>	<u>Amount</u>
0002AU	Sign Type H.1 - Identification & Directional	<u>14</u>	\$	<u>EA</u>	\$
0002AV	Blade Graphic Plaque Sign Type HH -Exit Info.	<u>3</u>	\$	<u>EA</u>	\$
0002AW	Sign Type I - Directional Blade Graphic	<u>10</u>	\$	<u>EA</u>	\$
0002AX	Installation of Sign Type I	<u>10</u>	\$	<u>EA</u>	\$
0002AY	Sign Type K - Stair Level Identification	<u>25</u>	\$	<u>EA</u>	\$
0002AZ	Sign Type L - Restroom Plaque	<u>96</u>	\$	<u>EA</u>	\$
0002BA	Installation of Sign Type L, M, and HH	<u>100</u>	\$	<u>EA</u>	\$
0002BB	Sign Type M - Accessible Restroom	<u>10</u>	\$	<u>EA</u>	\$
0002BC	Sign Type S - Amenity Identification	<u>9</u>	\$	<u>EA</u>	\$
0002BD	Installation of Sign Type S	<u>9</u>	\$	<u>EA</u>	\$
0002BE	Sign Type T - Self Schedule Conf. Rm.	<u>9</u>	\$	<u>EA</u>	\$
0002BF	Installation of Sign Type T	<u>9</u>	\$	<u>EA</u>	\$
0002BG	Sign Type V - Handicap Restriction	<u>10</u>	\$	EA	\$
0002BH	Sign Type W - Hours of Operation	<u>25</u>	\$	<u>EA</u>	\$
	Total of Extended Unit Prices (Amounts) for 0002BH for the Option Period I.	or Items No. 0	0002AA thro	ough	\$

OPTION PERIOD 2 Oct. 2008 to Oct. 2009 (Estimated)

Item <u>No.</u>	Description	Estimated Quantity	<u>Unit</u> <u>Price</u> **	<u>U/M</u>	<u>Amount</u>
0003AA	Sign Type A - Floor Level Identification	<u>10</u>	\$	<u>EA</u>	\$
0003AB	Installation of Sign Type A	<u>10</u>	\$	<u>EA</u>	\$
0003AC	Installation of Sign Type B.0	<u>10</u>	\$	<u>EA</u>	\$
0003AD	Installation of Sign Type B.1	<u>10</u>	\$	<u>EA</u>	\$
0003AE	Installation of Sign Type D, V, W	<u>20</u>	\$	<u>EA</u>	\$
0003AF	Sign Type B.0 - Room # Identification	<u>10</u>	\$	<u>EA</u>	\$
	Sign Type B.1 Room Description				
003AG	Sign Type B.1 - Room Description	<u>10</u>	\$	<u>EA</u>	\$
0003AH	Sign Type D - Destinations Directory	<u>10</u>	\$	<u>EA</u>	\$
0003AI	Sign Type E - Exit Directory (within elevator)	<u>10</u>	\$	<u>EA</u>	\$
0003AJ	Installation of Sign Type E	<u>10</u>	\$	<u>EA</u>	\$
0003AK	Sign Type F - Floor Directory	<u>10</u>	\$	<u>EA</u>	\$
0003AL	Installation of Sign Type F	<u>10</u>	\$	<u>EA</u>	\$
0003AM	Sign Type G - Secondary Directional	<u>10</u>	\$	<u>EA</u>	\$
0003AN	Installation of Sign Type G, G.1, K	<u>10</u>	\$	<u>EA</u>	\$
0003AP	Sign Type G.1 - Plaque	<u>10</u>	\$	<u>EA</u>	\$
0003AQ	Sign Type GG - Bldg. Announcement Directory	<u>10</u>	\$	<u>EA</u>	\$
0003AR	Installation of Sign Type GG	<u>10</u>	\$	<u>EA</u>	\$
0003AS	Sign Type H - Identification Blade	<u>10</u>	\$	<u>EA</u>	\$
0003AT	Installation of Sign Type H, H.1, and I	<u>20</u>	\$	<u>EA</u>	\$

Item <u>No.</u>	<u>Description</u>	Estimated Quantity	<u>Unit</u> Price**	U/M	Amount
	-	- _			
0003AU	Sign Type H.1 - Identification & Directional	<u>10</u>	\$	<u>EA</u>	\$
0003AV	Blade Graphic Plaque	<u>10</u>	\$	<u>EA</u>	\$
	Sign Type HH -Exit Info.				
0003AW	Sign Type I - Directional Blade Graphic	<u>10</u>	\$	<u>EA</u>	\$
0000177		4.0			•
0003AX	Installation of Sign Type I	<u>10</u>	\$	$\mathbf{\underline{EA}}$	\$
0003AY	Sign Type K - Stair Level Identification	<u>10</u>	\$	$\underline{\mathbf{E}}\mathbf{A}$	\$
0003AZ	Sign Type L - Restroom Plaque	<u>10</u>	\$	<u>EA</u>	\$
0003BA	Installation of Sign Type L, M, and HH	<u>20</u>	\$	$\underline{\mathbf{E}\mathbf{A}}$	\$
0003BB	Sign Type M - Accessible Restroom	<u>10</u>	\$	<u>EA</u>	\$
0003BC	Sign Type O.1 Member Id. Name	<u>10</u>	\$	<u>EA</u>	\$
0003BD	Sign Type O.2 Member Id. State Seal	<u>10</u>	\$	<u>EA</u>	\$
0003BE	Installation of Sign Type O.1 and O.2	<u>10</u>	\$	<u>EA</u>	\$
0003BF	Sign Type S - Amenity Identification	<u>10</u>	\$	<u>EA</u>	\$
0003BG	Installation of Sign Type S	<u>10</u>	\$	<u>EA</u>	\$
0003BH	Sign Type T - Self Schedule Conf. Rm.	<u>10</u>	\$	<u>EA</u>	\$
0003BI	Installation of Sign Type T	<u>10</u>	\$	<u>EA</u>	\$
0003BJ	Sign Type V - Handicap Restriction	<u>10</u>	\$	EA	\$
0003BK	Sign Type W - Hours of operation	<u>10</u>	\$	<u>EA</u>	\$
	Total of Extended Unit Prices (Amounts) for 0003BK for the Option Period 2.	or Items No. (0003AA thr	ough	\$

OPTION PERIOD 3 Oct. 2009 to Oct. 2010 (Estimated)

Item <u>No.</u>	Description	Estimated Quantity	<u>Unit</u> Price**	U/M	Amount
<u>110.</u>	<u>Description</u>	Quantity	<u>rrice</u>		Amount
0004AA	Sign Type A - Floor Level Identification	<u>10</u>	\$	<u>EA</u>	\$
0004AB	Installation of Sign Type A	<u>10</u>	\$	<u>EA</u>	\$
0004AC	Installation of Sign Type B.0	<u>10</u>	\$	<u>EA</u>	\$
000 4AD	Installation of Sign Type B.1	<u>10</u>	\$	<u>EA</u>	\$
0004AE	Installation of Sign Type D, V, W	<u>20</u>	\$	<u>EA</u>	\$
0004AF	Sign Type B.0 - Room # Identification	<u>10</u>	\$	<u>EA</u>	\$
0004AG	Sign Type B.1 Room Description	<u>10</u>	\$	<u>EA</u>	\$
0004AH	Sign Type D - Destinations Directory	<u>10</u>	\$	<u>EA</u>	\$
0004AI	Sign Type E - Exit Directory (within elevator)	<u>10</u>	\$	<u>EA</u>	\$
	,				
0004AJ	Installation of Sign Type E	<u>10</u>	\$	<u>EA</u>	\$
0004AK	Sign Type F - Floor Directory	<u>10</u>	\$	<u>EA</u>	\$
0004AL	Installation of Sign Type F	<u>10</u>	\$	<u>EA</u>	\$
0004AM	Sign Type G - Secondary Directional	<u>10</u>	\$	<u>EA</u>	\$
0004AN	Installation of Sign Type G, G.1, K	<u>20</u>	\$	<u>EA</u>	\$
0004AP	Sign Type G.1 - Plaque	<u>10</u>	\$	<u>EA</u>	\$
0004AQ	Sign Type GG - Bldg. Announcement Directory	<u>10</u>	\$	<u>EA</u>	\$
0004AR	Installation of Sign Type GG	<u>10</u>	\$	<u>EA</u>	\$

Item <u>No.</u>	Description	Estimated Quantity	<u>Unit</u> <u>Price</u> **	<u>U/M</u>	<u>Amount</u>
0004AS	Sign Type H - Identification Blade	<u>10</u>	\$	<u>EA</u>	\$
0004AT	Installation of Sign Type H, H.1, and I	<u>20</u>	\$	<u>EA</u>	\$
0004AU	Sign Type H.1 - Identification &	<u>10</u>	\$	<u>EA</u>	\$
0004AV	Directional Blade Graphic Plaque Sign Type HH -Exit Info.	<u>10</u>	\$	<u>EA</u>	\$
0004AW	Sign Type I - Directional Blade Graphic	<u>10</u>	\$	<u>EA</u>	\$
0004AX	Installation of Sign Type I	<u>10</u>	\$	<u>EA</u>	\$
0004AY	Sign Type K - Stair Level Identification	<u>10</u>	\$	<u>EA</u>	\$
0004AZ	Sign Type L - Restroom Plaque	<u>10</u>	\$	<u>EA</u>	\$
0004BA	Installation of Sign Type L, M, and HH	<u>20</u>	\$	<u>EA</u>	\$
0004BB	Sign Type M - Accessible Restroom	<u>10</u>	\$	<u>EA</u>	\$
0004BC	Sign Type O.1 Member Id. Name	<u>10</u>	\$	<u>EA</u>	\$
0004BD	Sign Type O.2 Member Id. State Seal	<u>10</u>	\$	<u>EA</u>	\$
0004BE	Installation of Sign Type O.1 and O.2	<u>10</u>	\$	<u>EA</u>	\$
0004BF	Sign Type S - Amenity Identification	<u>10</u>	\$	<u>EA</u>	\$
0004BG	Installation of Sign Type S	<u>10</u>	\$	<u>EA</u>	\$
0004BH	Sign Type T - Self Schedule Conf. Rm.	<u>10</u>	\$	<u>EA</u>	\$
0004BI	Installation of Sign Type T	<u>10</u>	\$	<u>EA</u>	\$
0004BJ	Sign Type V - Handicap Restriction	<u>10</u>	\$	EA	\$
0004BK	Sign Type W - Hours of Operation	<u>10</u>	\$	<u>EA</u>	\$
	Total of Extended Unit Prices (Amounts) for 0004BK for the Option Period 3.	or Items No. (0004AA thr	ough	\$

OPTION PERIOD 4 Oct. 2010 to Oct. 2011 (Estimated)

Item <u>No.</u>	<u>Description</u>	Estimated Quantity	<u>Unit</u> <u>Price</u> **	<u>U/M</u>	<u>Amount</u>
0005AA	Sign Type A - Floor Level Identification	<u>10</u>	\$	<u>EA</u>	\$
0005AB	Installation of Sign Type A	<u>10</u>	\$	<u>EA</u>	\$
0005AC	Installation of Sign Type B.0	<u>10</u>	\$	<u>EA</u>	\$
0005AD	Installation of Sign Type B.1	<u>10</u>	\$	<u>EA</u>	\$
0005AE	Installation of Sign Type D, V, W	<u>10</u>	\$	<u>EA</u>	\$
0005AF	Sign Type B.0 - Room # Identification	<u>10</u>	\$	<u>EA</u>	\$
0005AG	Sign Type B.1 Room Description	<u>10</u>	\$	<u>EA</u>	\$
0005AH	Sign Type D - Destinations Directory	<u>10</u>	\$	<u>EA</u>	\$
0005AI	Sign Type E - Exit Directory (within elevator)	<u>10</u>	\$	<u>EA</u>	\$
0005AJ	Installation of Sign Type E	<u>10</u>	\$	<u>EA</u>	\$
0005/ I 0	Sign Type F - Floor Directory	1 <u>0</u>	\$ \$	<u>EA</u>	\$
	, v		·		
0005AL	Installation of Sign Type F	<u>10</u>	\$	<u>EA</u>	\$
0005AM	Sign Type G - Secondary Directional	<u>10</u>	\$	<u>EA</u>	\$
0005AN	Installation of Sign Type G, G.1, K	<u>10</u>	\$	$\underline{\mathbf{E}\mathbf{A}}$	\$
0005AP	Sign Type G.1 - Plaque	<u>10</u>	\$	<u>EA</u>	\$
0005AQ	Sign Type GG - Bldg. Announcement Directory	<u>10</u>	\$	<u>EA</u>	\$
0005AR	Installation of Sign Type GG	<u>10</u>	\$	<u>EA</u>	\$
0005AS	Sign Type H - Identification Blade	<u>10</u>	\$	<u>EA</u>	\$
0005AT	Installation of Sign Type H, H.1, and I	<u>20</u>	\$	<u>EA</u>	\$

Item <u>No.</u>	Description	Estimated Quantity	<u>Unit</u> <u>Price</u> **	<u>U/M</u>	<u>Amount</u>
0005AU	Sign Type H.1 - Identification &	<u>10</u>	\$	<u>EA</u>	\$
0005AV	Directional Blade Graphic Plaque Sign Type HH -Exit Info.	<u>10</u>	\$	<u>EA</u>	\$
0005AW	Sign Type I - Directional Blade Graphic	<u>10</u>	\$	<u>EA</u>	\$
0005AX	Installation of Sign Type I	<u>10</u>	\$	<u>EA</u>	\$
0005AY	Sign Type K - Stair Level Identification	<u>10</u>	\$	<u>EA</u>	\$
0005AZ	Sign Type L - Restroom Plaque	<u>10</u>	\$	<u>EA</u>	\$
0005BA	Installation of Sign Type L, M, and HH	<u>20</u>	\$	$\underline{\mathbf{E}\mathbf{A}}$	\$
0005BB	Sign Type M - Accessible Restroom	<u>10</u>	\$	<u>EA</u>	\$
0005BC	Sign Type O.1 Member Id. Name	<u>10</u>	\$	<u>EA</u>	\$
0005BD	Sign Type O.2 Member Id. State Seal	<u>10</u>	\$	<u>EA</u>	\$
0005BE	Installation of Sign Type O.1 and O.2	<u>10</u>	\$	<u>EA</u>	\$
0005BF	Sign Type S - Amenity Identification	<u>10</u>	\$	<u>EA</u>	\$
0005BG	Installation of Sign Type S	<u>10</u>	\$	<u>EA</u>	\$
0005BH	Sign Type T - Self Schedule Conf. Rm.	<u>10</u>	\$	<u>EA</u>	\$
0005BI	Installation of Sign Type T	<u>10</u>	\$	<u>EA</u>	\$
0004BJ	Sign Type V - Handicap Restriction	<u>10</u>	\$	EA	\$
0005BK	Sign Type W - Hours of Operation	<u>10</u>	\$	<u>EA</u>	\$
	Total of Extended Unit Prices (Amounts) for 0005BK for Option Year 4.	or Items No. (0005AA thr	ough	\$

Total Price - Base Period plus All Option Years \$______
for Line Items No. 0001AA through 0005BK***

The unit price will govern if any errors in total pricing occur.

Please disregard the information shown on the next page. Go to page 12 for the Schedule notes.

Disregard th	<u>ie information (</u>	on this page!!!		
THI	IS PAGE IS BL	ANK.		

When pricing the Basic IDIQ contract, offerors should refer to the referenced drawings and attached specifications. The attached drawings and specifications will be used when Task Order No. 1, and all other task orders issued under the Basic IDIQ contract.

**Line item unit prices should include fully burdened labor rates, for installation of the signs.

***Failure to submit pricing on all line items may result in rejection of your offer.

2. ORDERING

The signage to be furnished under this Contract will be ordered by the authorized ordering officer through the issuance of individual Task Orders (See Section I, Contract Clause FAR 52.216-18 Ordering (OCT 1995). Funds under this contract will be obligated through the issuance of individual Task Orders.

3. MINIMUM AND MAXIMUM CONTRACT AMOUNTS

During the period specified in the "Supplementary Conditions" Article 1, the Government shall place orders totaling a minimum of \$10,000.00. The amount of all orders shall not exceed \$2,000,000.00.

4. A Pre-Bid Conference will be held on September 14, at 2:00 PM local time in the Ford House Office Building, Room 480, 2nd and D Streets, SW, Washington DC 20515.

END OF THE SCHEDULE

SECTION D

PACKAGING AND MARKING

	TABLE OF CONTENTS	Page 1	
ARTICLE NUMBER	ARTICLE NAME		PAGE NO.
D.1	PACKAGING	• • • • • • • • •	1
D.2	MARKING DELIVERABLES	• • • • • • • • • • • • • • • • • • • •	1
D.1	PACKAGING		
.1 packaging f	The item(s) procured under the contract shall be properly packet for shipment must meet manufacturer's recommended packing and packa		Packing and
D.2	MARKING DELIVERABLES		
manufactur	The signs shall be delivered with the drawing number, and size on containing signs shall be plainly and legibly marked with the following is er's name and drawing number. Identifying markings on cartons shall be or illegibly marked cartons will be returned to the Contractor at no cost	nformation: cont e indelible and wa	ract number, aterproofed.
.2	Mark deliverables for:		
	Item Nos. 0001AA through 0005BK:		
	The shipping location will be provided on each task order.	• • • • • • • • • • • • • • • • • • • •	

AOC52.211-7 IDENTIFICATION OF CONTRACT DELIVERABLES (NOV 2004)

Unless otherwise specified, all documents prepared and submitted by the Contractor to the Government under this contract shall include the following information on the cover page of each document:

- (a) Name and business address of the contractor;
- (b) Contract number;
- (c) Point of Contact; and
- (d) Date of transmittal.

(End of clause)

END OF SECTION D

SECTION E INSPECTION AND ACCEPTANCE

FAR 52.252-2 CLAUSES INCORPORATED BY REFERENCE (FEB 1998)

This contract incorporates one or more clauses by reference, with the same force and effect as if they were given in full text. Upon request, the Contracting Officer will make their full text available. Also, the full text of a clause may be accessed electronically at this/these addresses: www.gsa.gov or www.govcon.com

CLAUSE TITLE	DATE	<u>FAR</u>
<u>NUMBER</u>		
INSPECTION OF SUPPLIESFIXED-PRICE	AUG 1996	52.246-2
RESPONSIBILITY FOR SUPPLIES	APR 1984	52.246-16

(End of clause)

END OF SECTION E

SECTION F DELIVERIES OR PERFORMANCE

AOC52.211-4 TERM OF CONTRACT (JUN 2004)

The term of contract shall be from a base year of 12 months plus 4 one-year option periods. The total term of this contract is five years from the date of contract award. The contractor is requested to provide one delivery time for half of the total base year quantity that will include the submittal acceptance time, production time, delivery time, and installation time for half of the total base year estimated amount.

(End of clause)

FAR 52.252-2 CLAUSES INCORPORATED BY REFERENCE (FEB 1998)

This contract incorporates one or more clauses by reference, with the same force and effect as if they were given in full text. Upon request, the Contracting Officer will make their full text available. Also, the full text of a clause may be accessed electronically at this/these addresses: www.gsa.gov or www.govcon.com

CLAUSE TITLE	DATE	FAR
		NUMBER
STOP WORK ORDER	AUG 1989	52.242-15
F.O.B. DESTINATION	NOV 1991	52.247-34

END OF SECTION F

SECTION G CONTRACT ADMINISTRATION DATA

AOC52.201-1CONTRACTING OFFICER'S AUTHORITY (JUN 2004)

The Contracting Officer is the only person authorized to make or approve any changes in any of the requirements of this contract, notwithstanding any provision contained elsewhere in this contract. In the event that the Contractor makes any change at the direction of any person other than the Contracting Officer, the change will be considered to have been made without authority and no adjustment will be made in the contract price to cover any increase in costs incurred as a result thereof.

(End of clause)

AOC52.201-2 CONTRACTING OFFICER'S TECHNICAL REPRESENTATIVE (COTR) (MAR 2005)

The Government shall provide the name, address and telephone number of the COTR at the time of contract award and the duties thereby delegated to that person. Any subsequent change to the individual or the individual's responsibilities will be confirmed in writing by the Contracting Officer. In no instance will the COTR be delegated authority to order any change in the contractor's performance which would affect (a) cost or schedule for contracts for services or supplies, or (b) scope, the completion date for intermediate phases or milestones, or overall completion date for contracts for construction.

(End of clause)

AOC52.223-5 SPECIAL SECURITY REQUIREMENTS - SERVICES (AUG 2006)

- (a) All vehicles, and contents, used by the Contractor or his subcontractors, which enter or leave United States Government property during performance of the work, will be subject to clearance, inspection and identification procedures conducted by the United States Capitol Police.
- (b) All persons entering the Legislative Branch Buildings shall gain access to the building by passing through x-ray screening devices. In addition, all handbags and all hand-carried items shall be screened by x-ray devices prior to their entry into the building.
- (c) All personnel provided by the Contractor and employed on the site of the work will be subject to a security background investigation. Each employee will be required to fill out an I.D. Request Form and U.S. Capitol Police Request for check of Criminal History Records and each employee will be photographed and fingerprinted. The Contractor shall provide any assistance required by any of its employees in completing the forms.

- (d) Prior to commencement of work, the contractor and all designated on-site employees will be required, on a one-time basis, to be fingerprinted in Washington D.C. The location for the Electronic Fingerprinting Service is the U.S. Capitol Hill Police, Fairchild Building, 499 South Capitol Street SW, Washington, DC 20003.
- (e) Within seven (7) calendar days after the date of contract award, the Contractor shall submit to the Contracting Officer's Technical Representative (COTR) a list of all employees proposed to be employed on this contract. This list shall include the employee's full name, date of birth and social security number.
- (f) While security background investigations are in process, the Contractor's employees must not be granted access to the Capitol Hill complex to perform work or provide services for the AOC unless they are escorted by an AOC staff member. "Escorted" is defined to mean that the AOC staff member will remain with the employee(s) at all times during the performance of the work. Any of the Contractor's employees who are perceived by the Contracting Officer as a security risk as a result of evidence discovered in the background security investigation, will not be issued an Identification Card, will be denied access to the site of the work, and the Contractor will be directed to remove such employee from performance of any of the contract work, whether it be on or off the work site. Any contractor employee denied access to the site of work on a contract or task/delivery order as a result of a security investigation may not apply for access to any other AOC/U.S. Supreme Court contract or task/delivery order work site.
- (g) An identification card, with photograph, will be prepared for each employee of the Contractor requiring access to the site. The identification card shall be dated to indicate the period of time for which it is to remain valid from the date the employee reports for duty until the applicable date which occurs first: the expiration of the contract, or the last date of the employee's tour of duty with the Contractor. All contractor personnel must wear the ID badge whenever on the Capitol complex premises or when attending off-site functions on behalf of the AOC. ID badges must be worn in such a manner that contractor personnel can be easily identified as such.
- (h) All persons entering the Legislative Branch Buildings shall gain access to the building by passing through a magnetometer. In addition, all handbags and all hand-carried items shall be screened by x-ray devices prior to their entry into the building.
- (i) The Contractor is fully responsible to return:
- (1) The ID badge of any individual employee, including subcontractor personnel, who is removed for any reason including but not limited to illness, or dismissal;
- (2) The ID badges of all contractor employees, including subcontractor personnel, whose performance under the contract is completed in advance of final contract job completion; and
 - (3) All outstanding ID badges issued for the contractor and its employees, including subcontractor personnel, within 24 hours of on site contract job completion.
- (j) ID badges are to be hand delivered by the contractor within 24 hours of any of the events listed under (f) above to the Contracting Officer's Representative. (End of clause)

AOC52.223-7 SPECIAL SECURITY CLEARANCE AND INSPECTION PROCEDURES (JUN 2004)

- (a) All vehicles and contents used by the Contractor or his subcontractors which enter or leave United States Government property during performance of the work will be subject to clearance, inspection, and identification procedures conducted by the United States Capitol Police. See the attachment entitled "U.S. CAPITOL POLICE NOTICE" in Section J for instructions prior to delivery.
- (b) All persons entering the Legislative Branch Buildings shall gain access to the building by passing through x-ray screening devices. In addition, all handbags and all hand-carried items shall be screened by x-ray devices prior to entry into the building.

(End of clause)

AOC52.223-8 DELIVERY VEHICLE INSPECTION REQUIREMENTS (MAR 2006)

- (a) All vehicles and contents used by the Contractor or his subcontractors which enter or leave United States Government property during performance of work under this contract will be subject to clearance, inspection, and identification procedures conducted by the United States Capitol Police.
- (b) Mobile Vehicle and Cargo Inspection System (Mobile VACIS). All delivery vehicles carrying fuel, garbage, or similar cargo that cannot be offloaded for inspection and security screening shall utilize the Mobile VACIS located at Third and Pennsylvania Avenue, NW, Washington, DC, for inspection prior to making deliveries to any building within the Capitol Complex, including, but not limited to, the U.S. Capitol Building; the U.S. Botanic Garden; the Hart, Dirksen, and Russell Senate Office Buildings; the Rayburn, Longworth, Cannon, and Ford House Office Buildings; the Thomas Jefferson, John Adams, and James Madison Memorial Library of Congress buildings; the Capitol Power Plant; the Capitol Visitors Center; and the U.S. Supreme Court and Thurgood Marshall Federal Judiciary Buildings.
- (1) For deliveries requiring Mobile VACIS inspection, within seven calendar days or prior to the first delivery, the contractor shall provide the following information to the U.S. Capitol Police:
 - (i) List of drivers;
 - (ii) Date of birth for each driver;
 - (iii) Social Security Number of each driver;
 - (iv) Vehicle make;

- (v) Vehicle model;
- (vi) License tag number and state where vehicle is licensed;
- (vii) Color of vehicle; and
- (viii) Contractor name, if shown on the vehicle.
- (2) Information for deliveries made through the Mobile VACIS unit must be faxed to (202) 228-4313. For verification of receipt, the contractor may call (202) 224-9728.
- (3) Updates to the above information for Mobile VACIS deliveries must be sent to the U.S. Capitol Police throughout the period of performance of the contract.
- (c) 4700 Shepherd Parkway SW inspection facility. All other vehicles making deliveries to the above listed locations except for the Thomas Jefferson, John Adams, and James Madison Memorial Library of Congress buildings and the U.S. Supreme Court shall utilize the off-site inspection and screening facilities at 4700 Shepherd Parkway SW, Washington DC 20032.

(End of clause)

SECTION I CONTRACT CLAUSES

TABLE OF CONTENTS

AOC52.202-1	DEFINITIONS
AOC52.203-1	ADVERTISING/PROMOTIONAL MATERIALS
AOC52.203-2	DISCLOSURE OF INFORMATION TO THE GENERAL PUBLIC
AOC52.204-1	PRINTED OR COPIED DOUBLE-SIDED ON RECYCLED PAPER
AOC52.215-10	EXAMINATION OF RECORDS
FAR 52.216-18	ORDERING
FAR 52.216-19	ORDER LIMITATIONS
FAR 52.216-22	INDEFINITE QUANTITY
FAR 52.217-9	OPTION TO EXTEND THE TERM OF THE CONTRACT
AOC52.219-1	UTILIZATION OF SMALL BUSINESS CONCERNS
AOC52.222-3	CONVICT LABOR
FAR 52.223-3	HAZARDOUS MATERIAL IDENTIFICATION AND MATERIAL SAFETY DATA ALTERNATE I
AOC52.223-1 DATA SUPPLEM	HAZARDOUS MATERIAL IDENTIFICATION AND MATERIAL SAFETY IENT
AOC52.223-9	ACCIDENT PREVENTION AND SAFETY AND HEALTH PROGRAMS
AOC52.225-1	BUY AMERICAN ACT - SUPPLEMENT
AOC52.227-1	PATENT INDEMNITY - COMMERCIAL ITEMS
AOC52.232-1	PAYMENTS - SUPPLIES
AOC52.232-6 CENTRAL CONT	PAYMENT BY ELECTRONIC FUNDS TRANSFER - OTHER THAN TRACTOR REGISTRATION
AOC52.232-7	DISCOUNTS

AOC52.232-9	PAYMENT OF INTEREST ON CONTRACTOR CLAIMS
AOC52.232-12	ASSIGNMENT - SUPPLEMENT
AOC52.233-1	DISPUTES (JUN 2004)
AOC52.233-2 CLAIMS	CLAIMS FOR EQUITABLE ADJUSTMENTS - WAIVER AND RELEASE OF
AOC52.245-2	GOVERNMENT-FURNISHED PROPERTY
AOC52.246-3	WARRANTY OF COMMERCIAL ITEMS
FAR 52.252-2	CLAUSES INCORPORATED BY REFERENCE (FEB 1998)

SECTION I CONTRACT CLAUSES

AOC52.202-1 DEFINITIONS (JUN 2004)

- (a) The term "head of the agency" as used herein means the Committee, Commission, or other authority of the Legislative Branch of the Government having final jurisdiction or supervision over the work involved. The term "other authority" as used in this paragraph includes the Contracting Officer in cases in which he has final jurisdiction or supervision over the work involved.
- (b) The term "Architect" as used herein means the Architect of the Capitol.
- (c) The term "Contracting Officer" as used herein means the Architect of the Capitol or his duly authorized representative.
- (d) The term "his duly authorized representative" as used herein means any person or persons or board authorized to act for the head of the agency within the scope of their authority.
- (e) Except as otherwise provided in this contract, the term "subcontracts" includes purchase orders placed for performance under this contract.

(End of clause)

AOC52.203-1 ADVERTISING/PROMOTIONAL MATERIALS (JUN 2004)

- (a) It is the policy of the Congress to discourage contractors providing services and supplies to the Legislative Branch entities, including the Architect of the Capitol, from advertising practices that feature the Capitol and Capitol Complex in a manner in which conveys, or is reasonably calculated to convey, a false impression of sponsorship, approval or endorsement of any product or service by the Congress, the Government of the United States, or any Department, Agency or instrumentality thereof.
- (b) Contractors performing construction services for Legislative Branch entities, including the Architect of the Capitol, are discouraged from capitalizing on their contractual relationships with such entities and shall not engage in advertising practices which convey, or are reasonably calculated to convey, a false impression of sponsorship, approval or endorsement of any product or service by the Congress, the Government of the United States, of any Department, Agency or instrumentality thereof. This includes utilizing, in conjunction with the fact of their contractual relationship, images of the Capitol, any other buildings in the Capitol Complex, or any part of the United States Capitol Grounds in their advertising or promotional materials; and/or publishing or disseminating the aforementioned advertising or promotional materials.
- (c) The Contractor, by signing this contract, agrees to comply with the foregoing and to submit any proposed advertising or promotional copy connected in any manner with this contract and/or the Capitol, other Capitol Complex Buildings, or the United States Capitol Grounds to the Contracting Officer for approval prior to publication.

(End of clause)

AOC52.203-2 DISCLOSURE OF INFORMATION TO THE GENERAL PUBLIC (JUN 2004)

- (a) Promptly after receiving any request from the general public for information on or data derived from this contract, the contractor shall notify the Architect of the Capitol, Procurement Division. The contractor shall cooperate with the Procurement Division in compiling or collecting information or data if the Architect of the Capitol determines the information or data to be releasable.
- (b) "General public", for purposes of this clause, are those groups or individuals who are not authorized by law or regulation to have access.
- (c) This clause is not intended to prevent the contractor from providing contract information or data which the contractor is required to provide in order to conduct its business, such as insurance, banking, subcontracting.
- (d) The contractor is permitted to request that proprietary information or data not be released if such release would harm or impair the contractor in conducting its normal business. Such request must be documented with clear and specific grounds for that claim.

(End of clause)

AOC52.204-1 PRINTED OR COPIED DOUBLE-SIDED ON RECYCLED PAPER (JUN 2004)

The Contractor is encouraged to submit paper documents, such as offers, letters, or reports, that are printed or copied doubled-sided on recycled paper and meet minimum content standards when not using electronic commerce methods to submit information or data to the Government.

(End of clause)

AOC52.215-10 EXAMINATION OF RECORDS (JUN 2004)

- (a) The Contractor agrees that the Architect of the Capitol or any duly authorized representatives shall, until the expiration of 3 years after final payment under this contract, have access to and the right to examine any books, accounting procedures and practices documents, papers, records and other data regardless of whether such items are in written form, in the form of computer data or in any other form and other supporting evidence, involving transactions related to this contract or compliance with any clause or certification thereunder.
- (b) The Contractor further agrees to include in all its subcontracts hereunder a provision to the effect that subcontractor agrees that the Architect of the Capitol or any authorized representatives shall, until the expiration of 3 years after final payment under the subcontract, have access to and the right to examine books, documents, papers, records other data regardless of whether such items are in written form, in the form of computer data or in any other form, and other supporting evidence, involving transactions related to the subcontract or compliance with any clause or certification thereunder.

(c) The term "subcontract" as used in this clause excludes purchase orders not exceeding \$10,000.

(End of clause)

FAR 52.216-18 ORDERING (OCT 1995)

- (a) Any supplies and services to be furnished under this contract shall be ordered by issuance of delivery orders or task orders by the individuals or activities designated in the Schedule. Such orders may be issued from the date of award through five years after award.
- (b) All delivery orders or task orders are subject to the terms and conditions of this contract. In the event of conflict between a delivery order or task order and this contract, the contract shall control.
- (c) If mailed, a delivery order or task order is considered "issued" when the Government deposits the order in the mail. Orders may be issued orally, by facsimile, or by electronic commerce methods only if authorized in the Schedule.

(End of clause)

FAR 52.216-19 ORDER LIMITATIONS (OCT 1995)

- (a) Minimum order. When the Government requires supplies or services covered by this contract in an amount of less than \$10,000.00, the Government is not obligated to purchase, nor is the Contractor obligated to furnish, those supplies or services under the contract.
- (b) Maximum order. The Contractor is not obligated to honor--
 - (1) Any order for a single item in excess of \$1,000,000;
 - (2) Any order for a combination of items in excess of \$2,000,000; or
- (3) A series of orders from the same ordering office within 10 days that together call for quantities exceeding the limitation in paragraph (b)(1) or (2) of this section.
- (c) If this is a requirements contract (*i.e.*, includes the Requirements clause at subsection 52.216-21 of the Federal Acquisition Regulation (FAR)), the Government is not required to order a part of any one requirement from the Contractor if that requirement exceeds the maximum-order limitations in paragraph (b) of this section.
- (d) Notwithstanding paragraphs (b) and ©) of this section, the Contractor shall honor any order exceeding the maximum order limitations in paragraph (b), unless that order (or orders) is returned to the ordering office within 10 days after issuance, with written notice stating the Contractor's intent not to ship the item (or items) called for and the reasons. Upon receiving this notice, the Government may acquire the supplies or services from another source. (End of clause)

FAR 52.216-22 INDEFINITE QUANTITY(OCT 1995)

- (a) This is an indefinite-quantity contract for the supplies or services specified, and effective for the period stated, in the Schedule. The quantities of supplies and services specified in the Schedule are estimates only and are not purchased by this contract.
- (b) Delivery or performance shall be made only as authorized by orders issued in accordance with the Ordering clause. The Contractor shall furnish to the Government, when and if ordered, the supplies or services specified in the Schedule up to and including the quantity designated in the Schedule as the "maximum". The Government shall order at least the quantity of supplies or services designated in the Schedule as the "minimum".
- Except for any limitations on quantities in the Order Limitations clause or in the Schedule, there is no limit on the number of orders that may be issued. The Government may issue orders requiring delivery to multiple destinations or performance at multiple locations.
- (d) Any order issued during the effective period of this contract and not completed within that period shall be completed by the Contractor within the time specified in the order. The contract shall govern the Contractor's and Government's rights and obligations with respect to that order to the same extent as if the order were completed during the contract's effective period; *provided*, that the Contractor shall not be required to make any deliveries under this contract after 5 years after the award date.

(End of clause)

AOC52.219-1 UTILIZATION OF SMALL BUSINESS CONCERNS (AUG 2004)

- (a) It is the policy of the Government as declared by the Congress that a fair proportion of the purchases and contracts for supplies and services for the Government be placed with all types of small business concerns as determined by the size standards in 13 CFR 121.
- (b) The Contractor agrees to accomplish the maximum amount of subcontracting to all types of small business concerns that the Contractor finds to be consistent with the efficient performance of this contract.

(End of clause)

AOC52.222-3 CONVICT LABOR (JUN 2004)

In connection with the performance of work under this contract the Contractor agrees not to employ any person undergoing sentence of imprisonment except as provided by Public Law 89-176, approved September 10, 1965, 18 U.S.C. 4082©)(2). (End of clause)

FAR 52.223-3 HAZARDOUS MATERIAL IDENTIFICATION AND MATERIAL SAFETY DATA (JAN 1997) ALTERNATE I (JULY 1995)

- (a) "Hazardous material" as used in this clause, includes any material defined as hazardous under the latest version of Federal Standard No. 313 (including revisions adopted during the term of the contract).
- (b) The offeror must list any hazardous material, as defined in Paragraph (a) of this clause, to be delivered under this contract. The hazardous material shall be properly identified and include any applicable identification number, such as National Stock Number or Special Item Number. This information shall also be included on the Material Safety Data Sheet submitted under this contract.

Material	Identification No.	
(If none, insert "None")		
,		

- (c) This list must be updated during performance of the contract whenever the Contractor determines that any other material to be delivered under this contract is hazardous.
- (d) The apparently successful offeror agrees to submit, for each item as required prior to award a "Material Safety Data Sheet", meeting the requirement of 29 CFR 1910.1200(g) and the latest version of Federal Standard No. 313, for all hazardous material identified in Paragraph (b) of this clause. Data shall be submitted in accordance with Federal Standard No. 313, whether or not the apparently successful offeror is the actual manufacturer of these items. Failure to submit the Material Safety Data Sheet prior to award may result in the apparently successful offeror being considered nonresponsible and ineligible for award.
- (e) If, after award, there is a change in the composition of the items(s) or a revision to Federal Standard No. 313, which renders incomplete or inaccurate the data submitted under Paragraph (d) of this clause, the Contractor shall promptly notify the Contracting Officer and resubmit the data.
- (f) Neither the requirements of this clause nor any act or failure to act by the Government shall relieve the Contractor of any responsibility or liability for the safety of Government, Contractor, or subcontractor personnel or property.
- (g) Nothing contained in this clause shall relieve the Contractor from complying with applicable Federal, State and local laws, codes, ordinances, and regulations (including the obtaining of licenses and permits) in connection with hazardous material.
- (h) The Government's rights in data furnished under this contract with respect to hazardous material are as follows:

- (1) To use, duplicate and disclose any data to which this clause is applicable. The purposes of this right are to-
- (I) Apprise personnel of the hazards to which they may be exposed in using, handling, packaging, transporting, or disposing of hazardous materials;
 - (ii) Obtain medical treatment for those affected by the material; and
 - (iii) Have others use, duplicate and disclose the data for the Government for these purposes.
- (2) To use, duplicate and disclose data furnished under this clause, in accordance with subparagraph (h)(1) of this clause, in precedence over any other clause of this contract providing for rights in data.
- (3) The Government is not precluded from using similar or identical data acquired from other sources.
- (I) Except as provided in paragraph (I)(2), the Contractor shall prepare and submit a sufficient number of Material Safety Data Sheets (MSDS's), meeting the requirements of 29 CFR 1910.1200(g) and the latest version of Federal Standard No. 313, for all hazardous materials identified in paragraph (b) of this clause.
- (1) For items shipped to consignees, the Contractor shall include a copy of the MSDS's with the packing list or other suitable shipping document which accompanies each shipment. Alternatively, the Contractor is permitted to transmit MSDS's to consignees in advance of receipt of shipments by consignees, if authorized in writing by the Contracting Officer.
- (2) For items shipped to consignees identified by mailing address as agency depots, distribution centers or customer supply centers, the Contractor shall provide one copy of the MSDS' in or on each shipping container. If affixed to the outside of each container, the MSDS's must be placed in a weather resistant envelope.

(End of clause)

AOC52.223-1 HAZARDOUS MATERIAL IDENTIFICATION AND MATERIAL SAFETY DATA - SUPPLEMENT (JUN 2005)

- (a) Except as provided in paragraph ©), the Contractor shall prepare and submit a sufficient number of Material Safety Data Sheets (MSDS's), meeting the requirements of 29 CFR 1910.1200(g) and the latest version of Federal Standard No. 313, for all hazardous materials identified in FAR 52.223-3(b).
- (b) For items shipped to consignees, the Contractor shall include a copy of the MSDS's with the packing list or other suitable shipping document which accompanies each shipment. Alternatively, the Contractor is permitted to transmit MSDS's to consignees in advance of receipt of shipments by consignees, if authorized in writing by the Contracting Officer.

- (c) For items shipped to consignees identified by mailing address as agency depots, distribution centers or customer supply centers, the Contractor shall provide one copy of the MSDS' in or on each shipping container. If affixed to the outside of each container, the MSDS's must be placed in a weather resistant envelope.
- (d) For items provided to a construction site, the Contractor shall provide two copies of each MSDS. One copy shall be provided to the COTR in accordance with the Division 1 submittal requirements, and a second copy shall be kept in an MSDS binder on the job site.

(End of clause)

AOC52.223-9 ACCIDENT PREVENTION AND SAFETY AND HEALTH PROGRAMS (SEP 2004)

- (a) The Contractor shall comply with the safety and health standards published in 41 C.F.R. Part 50-205, including any matters incorporated by reference therein.
- (b) The Contractor shall also comply with the regulations issued by the Secretary of Labor pursuant to the Williams-Steiger Occupational Safety and Health Act of 1970, as set forth in Title 29 of the Code of Federal Regulations.
- (c) The Contractor shall bring to the attention of the Architect any work encountered that may involve entry into a suspected confined space as defined by OSHA. A determination will be made by the Architect, and if the areas is deemed a permit required confined space, additional protective measures will be needed, per OSHA requirements.
- (d) In the event that conditions on the site pose an imminent danger or threat to the Contractor's workers, the public, Government employees, other persons, or to Capitol complex structures and property of historical significance, the Contracting Officer can verbally order the Contractor to stop work operations in the specified area until said conditions are corrected to the Contracting Officer's satisfaction. The Contracting Officer shall promptly issue a written order to stop the work to the Contractor formalizing the specifics of the verbal stop work order.
- (e) The Contractor shall not be entitled to any equitable adjustment of the contract price or extension of the performance schedule on any stop work order issued under this clause.

(End of clause)

AOC52,225-1 BUY AMERICAN ACT - SUPPLEMENT (JUN 2004)

In addition to provisions of the above clause entitled, "Buy American Act", the General Provisions of the Legislative Branch Appropriations Act provides in part, as follows:

- (a) It is the sense of the Congress that, to the greatest extent practicable, all equipment and products purchased with funds made available in the Act should be American-made.
- (b) In providing financial assistance to or entering into any contract with, any entity using funds made available in the Act, the head of each Federal Agency, to the greatest extent practicable, shall provide to such entity a notice describing the statement made in Paragraph (a) above, by the Congress. (End of clause)

AOC52.232-1 PAYMENTS - SUPPLIES (JUN 2004)

- (a) The Contractor shall be paid, upon the submission of proper invoices or vouchers, the prices stipulated herein for supplies delivered and accepted or services rendered and accepted, less deductions, if any, as herein provided. Unless otherwise specified, payment will be made on partial deliveries accepted by the Government when the amount due on such deliveries so warrants; or, when requested by the Contractor and not otherwise specified, payment for accepted partial deliveries shall be made whenever such payment would equal 50 percent of the total amount of this contract.
- (b) If partial payments are to be made, all material and work covered by partial payments made shall thereupon become the sole property of the Government, but this provision shall not be construed as relieving the Contractor from the sole responsibility of fulfilling contractual requirements for all material and work upon which payments have been made or the restoration of any damaged work, or as waiving the right of the Government to require the fulfillment of all of the terms of the contract.
- (c) Upon completion and acceptance of all work, the amount due the Contractor under this contract will be paid upon the presentation of a properly executed invoice and after the Contractor shall have furnished the Government with a release, if required, of all claims against the Government arising under and by virtue of this contract, other than claims, if any, in stated amounts as may be specifically excepted by the Contractor from the operation of the release. If the Contractor's claim to amounts payable under the contract has been assigned under the Assignment of Claims Act of 1940, as amended (31 U.S.C. 3727, 41 U.S.C. 15), a release may also be required of the assignee.
- (d) Until further notice, properly certified invoices shall be FAXED, in triplicate, to the Accounting Office, Architect of the Capitol at 202-226-2580. Information concerning requirements for payment requisitions must be secured by telephoning the Accounting Officer at (202) 226-2552. To assist the AOC in making timely payments, the Contractor is requested to furnish the following additional information on the invoice:
 - (1) Contract number;
 - (2) Name, address and Taxpayer I.D.of Contractor;
 - (3) Invoice Date; and
- (4) Amount by line item including quantity and unit pricing (see the "SCHEDULE OF ITEMS" in Section B)

(e) Payments will be made directly to the contractor's financial institution through Direct Deposit/Electronic Funds Transfer (DD/EFT). The Contractor's attention is directed to the requirements of AOC52.232-6, Payment by Electronic Funds Transfer - Other Than Central Contractor Registration.

(End of clause)

AOC52.232-6 PAYMENT BY ELECTRONIC FUNDS TRANSFER - OTHER THAN CENTRAL CONTRACTOR REGISTRATION (JUN 2004)

- (a) Method of payment. (1) All payments by the Government under this contract shall be made by electronic funds transfer (EFT) except as provided in paragraph (a)(2) of this clause. As used in this clause, the term "EFT" refers to the funds transfer.
- (2) In the event the Government is unable to release one or more payments by EFT, the contractor agrees to either--
 - (I) Accept payment by check or some other mutually agreeable method of payment; or
- (ii) Request the Government to delay payment until such time as the Government makes payment by EFT (but see paragraph (d)).
- (b) Mandatory submission of Contractor's EFT information. (1) The Contractor is required to provide the Government with the information required to make payment by EFT (see paragraph (I) of this clause). The contractor shall provide this information directly to the office designated in paragraph (k) to receive that information (hereafter: "designated office") by three working days after notification of contract award. If not otherwise specified in this contract, the payment office is the designated office for receipt of the contractor's EFT information. If more than one designated office is named for the contract, the contractor shall provide a separate notice to each office. In the event that the EFT information changes, the contractor shall be responsible for providing the updated information to the designated office(s).
- (2) If the contractor provides EFT information applicable to multiple contracts, the contractor shall specifically state the applicability of this EFT information in terms acceptable to the designated office. However, EFT information supplied to a designated office shall be applicable only to contracts that identify that designated office as the office to receive EFT information for that contract.
- (c) Mechanisms for EFT payment. The Government may make payment by EFT through the Automated Clearing House (ACH) network, subject to the rules of the National Automated Clearing House Association. The rules governing Federal payments through the ACH are contained in 31 CFR part 210.
- (d) Suspension of payment. (1) Notwithstanding the provisions of any other clause of this contract, the Government is not required to make any payment under this contract until after receipt, by the designated payment office, of the correct EFT payment information from the Contractor. Until receipt

of the correct EFT information, any invoice or contract financing request shall be deemed not to be a valid invoice.

- (2) If the EFT information changes after submission of correct EFT information, the Government shall begin using the changed EFT information no later than the 30 days after its receipt by the designated office to the extent payment is made by EFT. However, the Contractor may request that no further payments be made until the changed EFT information is implemented by the payment office.
- (e) Liability for uncompleted or erroneous transfers. (1) If an uncompleted or erroneous transfer occurs because the Government failed to use the Contractor-provided EFT information in the correct manner, the Government remains responsible for--
 - (I) Making a correct payment; and
 - (ii) Recovering any erroneously directed funds.
- (2) If an uncompleted or erroneous transfer occurs because Contractor's EFT information was incorrect at the time of Government release or was revised within 30 days of Government release of the EFT payment transaction instruction to the Federal Reserve System, and
- (I) If the funds are no longer under the control of the payment office, the Government is deemed to have made payment and the Contractor is responsible for recovery of any erroneously directed funds; or
- (ii) If the funds remain under the control of the payment office, the Government shall not make payment and the provisions of paragraph (d) shall apply.
- (f) EFT and assignment of claims. If the contractor assigns the proceeds of this contract as provided for in the assignment of claims terms of this contract, the contractor shall require as a condition of any such assignment that the assignee shall provide the EFT information required by paragraph (I) of this clause to the designated office and shall be paid by EFT in accordance with the terms of this clause. In all respects, the requirements of this clause shall apply to the assignee as if it were the contractor. EFT information that shows the ultimate recipient of the transfer to be other than the contractor, in the absence of a proper assignment of claims acceptable to the Government, is incorrect EFT information within the meaning of Paragraph (d) of this clause.
- (g) Liability for change of EFT information by financial agent. The Government is not liable for errors resulting from changes to EFT information provided by the contractor's financial agent.
- (h) Payment information. The payment or disbursing office shall forward to the Contractor available payment information that is suitable for transmission as of the date of release of the EFT instruction to the Federal Reserve System. The Government may request the Contractor to designate a desired format and method(s) for delivery of payment information from a list of formats and methods the payment office is capable of executing. However, the Government does not guarantee that any particular format or method of delivery is available at any particular payment office and retains the

latitude to use the format and delivery method most convenient to the Government. If the Government makes payment by check in accordance with paragraph (a) of this clause, the Government shall mail the payment information to the remittance address in the contract.

- (I) EFT Information. The contractor shall provide the following information to the designated payment office. The contractor may supply this data for this or multiple contracts (see paragraph (b) of this clause). The Contractor shall designate a single financial agent per contract capable of receiving and processing the EFT information using the EFT methods described in paragraph ©) of this clause. The information required is as follows:
 - (1) The contract number;
 - (2) The contractor's name and remittance address as stated in the contract(s);
- (3) The signature (manual or electronic, as appropriate), title, and telephone number of the contractor's official authorized to provide this information;
- (4) The name, address, and 9-digit Routing Transit Number of the contractor's financial agent; and
 - (5) The contractor's account number and the type of account (checking, saving or lockbox).
- (j) The Contractor shall send all EFT information, and any changes to EFT information to the office designated in paragraph (k) of this clause. The Contractor shall not send EFT information to the payment office, or any other office than that designated in paragraph (k). The Government need not use any EFT information sent to any office other than that designated in paragraph (k).
- (k) Designated office:

Name:

Architect of the Capital Accounting Division Mailing Address: 2nd and D Streets SW Ford House Office Building Washington, DC 20515 Telephone: (202) 226-2552 Facsimile: (202) 225-7321

(End of clause)

AOC52.232-7 DISCOUNTS (AUG 2004)

(a) Discounts for prompt payment will not be considered in the evaluation of offers. However, any offered discount will form a part of the award, and will be taken if payment is made within the discount period indicated in the offer by the offeror. As an alternative to offering a prompt payment

discount in conjunction with the offer, offerors awarded contracts may include prompt payment discounts on individual invoices.

(b) In connection with any discount offered for prompt payment, time shall be computed from the date of the invoice. If the Contractor has not placed a date on the invoice, the due date shall be calculated from the date the designated billing office receives a proper invoice, provided the agency annotates such invoice with the date of receipt at the time of receipt. For the purpose of computing the discount earned, payment shall be considered to have been made on the date that appears on the payment check or, for an electronic funds transfer, the specified payment date. When the discount date falls on a Saturday, Sunday, or legal holiday and, for work performed in the District of Columbia, Presidential Inauguration Day, when Federal Government offices are closed and Government business is not expected to be conducted, payment may be made on the following business day. (End of clause)

AOC52.232-9 PAYMENT OF INTEREST ON CONTRACTOR CLAIMS (JUN 2004)

- (a) If an appeal is filed by the Contractor from a final decision of the Contracting Officer under the Disputes paragraph of this contract, denying a claim arising under the contract, simple interest on the amount of the claim finally determined owed by the Government shall be payable to the Contractor. Such interest shall be at the rate determined by the Secretary of the Treasury pursuant to Public Law 92-41, 85 Stat. 97, from the date the Contractor furnishes to the Contracting Officer his written appeal under the Disputes paragraph of this contract, to the date of (1) a final judgement by a court of competent jurisdiction, or (2) mailing to the Contractor of a change order, or a supplemental agreement for execution either confirming completed negotiations between the parties or carrying out a decision of a contract appeals board.
- (b) Notwithstanding Paragraph (a) above, (1) interest shall be applied only from the date payment was due, if such date is later than the filing of appeal, and (2) interest shall not be paid for any period of time that the Contracting Officer determines the Contractor has unduly delayed in pursuing his remedies before a board of contract appeals or a court of competent jurisdiction.

(End of clause)

AOC52.232-12 ASSIGNMENT - SUPPLEMENT (SEP 2004)

Neither the contract nor any interest therein shall be assigned. However, moneys due or to become due under the contract may be assigned in accordance with the provisions of FAR clause 52.232-23 (ASSIGNMENT OF CLAIMS) as incorporated by reference in Section I.

(End of clause)

AOC52.233-1 DISPUTES (JUN 2004)

(a) Except as otherwise provided in this contract, any dispute concerning a question of fact arising under this contract which is not disposed of by agreement shall be decided by the Contracting Officer, who shall reduce his decision to writing and mail or otherwise furnish a copy thereof to the

Contractor. The decision of the Contracting Officer shall be final and conclusive unless, within 30 days from the date of receipt of such copy, the Contractor mails or otherwise furnishes to the Contracting Officer a written appeal addressed to the head of the agency involved. The decision of the head of the agency or his duly authorized representative for the determination of such appeals shall be final and conclusive. This provision shall not be pleaded in any suit involving a question of fact arising under this contract as limiting judicial review of any such decision to cases where fraud by such official or his representative or board is alleged; provided, however, that any such decision shall be final and conclusive unless the same is fraudulent or capricious or arbitrary or so grossly erroneous as necessarily to imply bad faith or is not supported by substantial evidence. In connection with any appeal proceeding under this paragraph, the Contractor shall be afforded an opportunity to be heard and to offer evidence in support of his appeal. Pending final decision of a dispute hereunder, the Contractor shall proceed diligently with the performance of the contract and in accordance with the Contracting Officer's decision.

(b) This paragraph does not preclude consideration of questions of law in connection with decisions provided for in Paragraph (a) above. Nothing in this contract, however, shall be construed as making final the decision of any administrative official, representative, or board on a question of law.

(End of clause)

AOC52.233-2 CLAIMS FOR EQUITABLE ADJUSTMENTS - WAIVER AND RELEASE OF CLAIMS

(JUN 2004)

- (a) Whenever the Contractor submits a claim for equitable adjustment under any paragraph of this contract which provides for equitable adjustment of the contract, such claim shall include all types of adjustments in the total amounts to which the paragraph entitles the Contractor, including but not limited to adjustments arising out of delays or disruptions or both caused by such change. Except as the parties may otherwise expressly agree, the Contractor shall be deemed to have waived (1) any adjustments to which it otherwise might be entitled under the paragraph where such claims fail to request such adjustments, and (2) any increase in the amount of equitable adjustments additional to those requested in its claim.
- (b) Further, the Contractor agrees that, if required by the Contracting Officer, he will execute a release, in form and substance satisfactory to the Contracting Officer, as part of the supplemental agreement setting forth the aforesaid equitable adjustment, and that such release shall discharge the Government, its officers, agents and employees, from any further claims, including but not limited to further claims arising out of delays or disruptions or both, caused by the aforesaid change.

(End of clause)

AOC52.246-3 WARRANTY OF COMMERCIAL ITEMS (JUN 2004)

The Contractor warrants and implies that the items delivered hereunder are merchantable and fit for use for the particular purpose described in this contract. (End of clause)

FAR 52.252-2 CLAUSES INCORPORATED BY REFERENCE (FEB 1998)

This contract incorporates one or more clauses by reference, with the same force and effect as if they were given in full text. Upon request, the Contracting Officer will make their full text available. Also, the full text of a clause may be accessed electronically at this/these addresses: www.gsa.gov or www.govcon.com

CLAUSE TITLE	DATE	FAR
		NUMBER
GRATUITIES	APR 1984	52.203-3
COVENANT AGAINST CONTINGENT FEES	APR 1984	52.203-5
RESTRICTIONS ON SUBCONTRACTOR SALES TO TH	IEJUL 1995	52.203-6
GOVERNMENT		
WALSH-HEALEY PUBLIC CONTRACTS ACT	DEC 1996	52.222-20
EQUAL OPPORTUNITY	APR 2002	52.222-26
EQUAL OPPORTUNITY FOR SPECIAL DISABLED		
VETERANS, VETERANS OF THE VIETNAM ERA		
AND OTHER ELIGIBLE VETERANS	DEC 2001	52.222-35
AFFIRMATIVE ACTION FOR WORKERS WITH		
DISABILITIES	JUN 1998	52.222-36
EMPLOYMENT REPORTS ON SPECIAL DISABLED		
VETERANS, VETERANS OF THE VIETNAM ERA,		
AND OTHER ELIGIBLE VETERANS	DEC 2001	52.222-37
DRUG-FREE WORKPLACE	MAY 2001	52.223-6
BUY AMERICAN ACT - SUPPLIES	JUN 2003	52.225-1
FEDERAL, STATE AND LOCAL TAXES	APR 2003	52.229-3
EXTRAS	APR 1984	52.232-11
ASSIGNMENT OF CLAIMS	JAN 1986	52.232-23
BANKRUPTCY	JULY 1995	52.242-13
CHANGESFIXED-PRICE	AUG 1987	52.243-1
TERMINATION FOR CONVENIENCE OF THE		
GOVERNMENT (FIXED-PRICE)	MAY 2004	52.249-2
DEFAULT (FIXED-PRICE SUPPLY AND SERVICE)	APR 1984	52.249-8
ANTI-KICKBACK PROCEDURES	JUL 2005	52.203-7
CANCELLATION, RESCISSION, AND RECOVERY OF		
FUNDS FOR ILLEGAL OR IMPROPER ACTIVITY	JAN 1997	52.203-8
PROTECTING THE GOVERNMENT'S INTEREST WHEN		
SUBCONTRACTING WITH CONTRACTORS		
DEBARRED, SUSPENDED, OR PROPOSED		
FOR DEBARMENT	JAN 2005	52.209-6
AUDIT AND RECORDS - NEGOTIATION	JUN 1999	52.215-2
END OF SECTION I		

SECTION J LIST OF ATTACHMENTS

PAYMENT INFORMATION FORM, ACH VENDOR PAYMENT SYSTEM

Division 1, General Requirements

Section 10430 - Directories, June 21, 2006

Section 10431 - Signs, June 2006

Request for Check of Criminal History Records

Payment Information Form - ACH Vendor Payment System + Notice

Off Site Delivery Center Instruction

AOC Past Performance Questionaire

(The following List of Drawings are provided for information purposes only.) (Copies of drawings may be obtained by requesting them by e-mail to the Attention of Mr. John Friedhoff at jfriedho@aoc.gov, or by FAX # (202)225-3221 to the Attention: Mr. John Friedhoff.

- A Level Identification
- **B.0 Room Number ID**
- **B.1 Room Description**
- **D** Destinations Directory
- **E Exit Directory within Elevator**
- F Floor Directory/Directional
- **G** Secondary Directional
- G.1 Plaque
- **GG** Plaque
- H Identification Blade Graphic
- H.1 Ident. & Direct. Blade Graphic
- HH Plaque
- **K** Stair Level Identification
- L Restroom Plaque
- **S Amenity Identification**
- W Plaque (For example see Type D)

END OF SECTION J

SECTION K REPRESENTATIONS, CERTIFICATIONS AND OTHER STATEMENTS OF OFFERORS

TABLE OF CONTENTS

FAR 52.203-2	CERTIFICATE OF INDEPENDENT PRICE DETERMINATION (APR 1985)
FAR 52.204-3	TAXPAYER IDENTIFICATION
AOC52.204-2	DATA UNIVERSAL NUMBERING SYSTEM (DUNS) NUMBER
AOC52.204-3	REPRESENTATIONS AND CERTIFICATIONS
FAR 52.209-5	CERTIFICATION REGARDING DEBARMENT, SUSPENSION, PROPOSED DEBARMENT, AND OTHER RESPONSIBILITY MATTERS
AOC52.215-8	AUTHORIZED NEGOTIATORS
FAR 52.225-2	BUY AMERICAN CERTIFICATE

SECTION K

REPRESENTATIONS, CERTIFICATIONS AND OTHER STATEMENTS OF OFFERORS

FAR 52.203-2 CERTIFICATE OF INDEPENDENT PRICE DETERMINATION (APR 1985)

- (a) The offeror certifies that -
- (1) The prices in this offer have been arrived at independently, without, for the purpose of restricting competition, any consultation, communication, or agreement with any other offeror or competitor relating to -
 - (I) Those prices;
 - (ii) The intention to submit an offer; or
 - (iii) The methods or factors used to calculate the prices offered;
- (2) The prices in this offer have not been and will not be knowingly disclosed by the offeror, directly or indirectly, to any other offeror or competitor before bid opening (in the case of a sealed bid solicitation) or contract award (in the case of a negotiated solicitation) unless otherwise required by law; and --
- (3) No attempt has been made or will be made by the offeror to induce any other concern to submit or not to submit an offer for the purpose of restricting competition.
- (b) Each signature on the offer is considered to be a certification by the signatory that the signatory -
- (1) Is the person in the offeror's organization responsible for determining the prices being offered in this bid or proposal, and that the signatory has not participated and will not participate in any action contrary to paragraphs (a)(1) through (a)(3) of this provision; or
- (2)(I) Has been authorized, in writing, to act as agent for the following principals in certifying that those principals have not participated, and will not participate in any action contrary to paragraphs (a)(1) through (a)(3) of this provision

[insert full name of person(s) in the offeror's organization responsible for determining the prices offered in this bid or proposal, and the title of his or per position in the offeror's organization];

- (ii) As an authorized agent, does certify that the principals named in subdivision (b)(2)(I) of this provision have not participated, and will not participate, in any action contrary to paragraphs (a)(1) through (a)(3) of this provision; and
- (iii) As an agent, has not personally participated, and will not participate, in any action contrary to paragraphs (a)(1) through (a)(3) of this provision.

(c) If the offeror deletes or modifies paragraph (a)(2) of this provision, the offeror must furnish with its offer a signed statement setting forth in detail the circumstances of the disclosure.				
(End of provision)				
FAR 52.204-3 TAXPAYER IDENTIFICATION (OCT 1998)				
(a) Definitions.				
"Common parent," as used in this provision, means that corporate entity that owns or controls an affiliated group of corporations that files its Federal income tax returns on a consolidated basis, and of which the offeror is a member.				
"Taxpayer Identification Number (TIN)," as used in this provision, means the number required by the Internal Revenue Service (IRS) to be used by the offeror in reporting income tax and other returns. The TIN may be either a Social Security Number or an Employer Identification Number.				
(b) All offerors must submit the information required in paragraphs (d) through (f) of this provision to comply with debt collection requirements of 31 U.S.C. 7701©) and 3325(d), reporting requirements of 26 U.S.C. 6041, 6041A, and 6050M, and implementing regulations issued by the IRS. If the resulting contract is subject to the payment reporting requirements described in Federal Acquisition Regulation (FAR) 4.904, the failure or refusal by the offeror to furnish the information may result in a 31 percent reduction of payments otherwise due under the contract.				
(c) The TIN may be used by the Government to collect and report on any delinquent amounts arising out of the offeror's relationship with the Government (31 U.S.C. 7701(c)(3)). If the resulting contract is subject to the payment reporting requirements described in FAR 4.904, the TIN provided hereunder may be matched with IRS records to verify the accuracy of the offeror's TIN.				
(d) Taxpayer Identification Number (TIN).				
TIN:				
TIN has been applied for.				
TIN is not required because:				
Offeror is a nonresident alien, foreign corporation, or foreign partnership that does not have income effectively connected with the conduct of a trade or business in the United States and does not have an office or place of business or a fiscal paying agent in the United States;				
Offeror is an agency or instrumentality of a foreign government;				
Offeror is an agency or instrumentality of a Federal government;				

(e)	Type of organization.		
		Sole proprietorship;	
		Partnership;	
		Corporate entity (not tax-exempt);	
		Corporate entity (tax-exempt);	
		Government entity (Federal, State, or local);	
		Foreign government	
		International organization per 26 CFR 1.6049-4;	
		Other	
(f)	Comn	non Parent.	
		Offeror is not owned or controlled by a common parent as defined in paragraph (a) of this provision.	
		Name and TIN of common parent:	
	Nar	me	
	TIN	I	
(En	d of pro	ovision)	
AO	C 52.20	4-2 DATA UNIVERSAL NUMBERING SYSTEM (DUNS) NUMBER (JUN 2004)	
	ror's na	fferor shall enter, in the space provided below, the DUNS number that identifies the ame and address exactly as stated in the offer. The DUNS number is a nine-digit number Dun and Bradstreet Information Services.	
For call	in one. inform	offeror does not have a DUNS number, it should contract Dun and Bradstreet directly to A DUNS number will be provided immediately by telephone at no charge to the offeror. ation on obtaining a DUNS number, the offeror, if located within the United States, should ad Bradstreet at 1-800-333-0505. The offeror should be prepared to provide the following in:	
	(1)	Company name,	
	(2)	Company address;	

	(4)	Line of business;
	(5)	Chief executive officer/key manager;
	(6)	Date the company was started;
	(7)	Number of people employed by the company; and
	(8)	Company affiliation.
Dun http:	and Br <u>//www.</u>	rs located outside the United States may obtain the location and phone number of the local radstreet Information Services office from the Internet home page at customerservice@dnb.com. If an offeror is unable to locate a local service center, it may hail to Dun and Bradstreet at globalinfo@mail.dnb.com.
(d)	Enter	DUNS number:
(End	of pro	vision)
AOC	52.204	-3 REPRESENTATIONS AND CERTIFICATIONS (NOV 2004)
conta		shall properly execute and submit with its offer the Representations and Certifications erein. Insert information in spaces provided as applicable. vision)
FAR	52.209	-5 CERTIFICATION REGARDING DEBARMENT, SUSPENSION, PROPOSED DEBARMENT, AND OTHER RESPONSIBILITY MATTERS (DEC 2001)
(a)(1)) The	Offeror certifies, to the best of its knowledge and belief, that—
	(I)	The offeror and/or any of its Principals –
decla	red ine	(A) Are () are not () presently debarred, suspended, proposed for debarment, or eligible for the award of contracts by any Federal agency;
offen local) of off	se in co contra fers; or	(B) Have () have not (), within a three-year period preceding this offer, been for had a civil judgment rendered against them for: commission of fraud or a criminal connection with obtaining, attempting to obtain, or performing a public (Federal, state, or act or subcontract; violation of Federal or state antitrust statutes relating to the submission commission of embezzlement, theft, forgery, bribery, falsification or destruction of records, e statements, tax evasion, or receiving stolen property; and
charş	ged by	(C) Are () are not () presently indicted for, or otherwise criminally or civilly a governmental entity with, commission of any of the offenses enumerated in paragraph

(3)

Company telephone number;

(a)(1)(i)(B) of this provision.	
(ii) The Offeror has () has not (), within a three-year period preceding this of or more contracts terminated for default by any Federal agency.	fer, had one
(2) "Principals," for the purposes of this certification, means officers; directors; of partners; and, persons having primary management or supervisory responsibilities within entity (e.g., general manager; plan manager; head of a subsidiary, division, or business se similar positions).	n a business
This Certification Concerns a Matter Within the Jurisdiction of an Agency of the United the Making of a False, Fictitious, or Fraudulent Certification May Render the Maker Sub Prosecution Under Section 1001, Title 18, United States Code.	
(c) The Offeror shall provide immediate written notice to the Contracting Officer if, at a prior to contract award, the Offeror learns that its certification was erroneous when subn become erroneous by reason of changed circumstances.	•
(d) A certification that any of the items in paragraph (a) of this provision exists will not result in withholding of an award under this solicitation. However, the certification will be in connection with a determination of the Offeror's responsibility. Failure of the Offeror certification or provide such additional information as requested by the Contracting Office render the Offeror nonresponsible.	e considered to furnish a
(e) Nothing contained in the foregoing shall be construed to require establishment of a s	system of

records in order to render, in good faith, the certification required by paragraph (a) of this provision.

The certification in paragraph (a) of this provision is a material representation of fact upon which reliance was placed when making award. If it is later determined that the Offeror knowingly rendered an erroneous certification, in addition to other remedies available to the Government, the

The knowledge and information of an Offeror is not required to exceed that which is normally

Contracting Officer may terminate the contract resulting from this solicitation for default.

The offeror represents that following persons are authorized to negotiate on its behalf with the

AOC52.215-8 **AUTHORIZED NEGOTIATORS (JUN 2004)**

possessed by a prudent person in the ordinary course of business dealings.

(f)

(End of provision)

Government in connection with this Request for Proposal: Title Name E-Mail:

Nam	<u>ne</u>	<u>Title</u>	
Tele	phone:	<u>E-Mail:</u>	
Nam	10		
	<u>phone</u> :	, 	
(End	d of provision)		
FAR	R 52.225-2 BUY AMERICA	N CERTIFICATE (JUNE 2003)	
been prod prod and	•	ured outside the United States. Tactured in the United States that "domestic end product", "end p	roduct", "foreign end product",
			_ _
			_
	(Li	ist as Necessary)	
(c)	The Government will evaluate the Federal Acquisition Regula		lices and procedures of Part 25 of
(End	d of provision)		
END	O OF SECTION K		

Wayfinding Signs

Page 44

RFP NO. 060141

SECTION L INSTRUCTIONS, CONDITIONS, AND NOTICES TO OFFERORS

TABLE OF CONTENTS

- 1. PROPOSAL COMPOSITION
- 2. INSTRUCTIONS FOR PREPARING THE TECHNICAL PROPOSAL
- 3. INSTRUCTIONS FOR PREPARING THE PRICE PROPOSAL
- 4. AOC52.215-2 INTERPRETATIONS AND AMENDMENTS
- 5. AOC52.215-3 RESTRICTION ON DISCLOSURE AND USE OF DATA
- 6. FAR 52.216-1 TYPE OF CONTRACT

SOLICITATION CONDITIONS

- 1. PROPOSAL COMPOSITION (AOC) (NOV 1999)
- 1.1 Proposals shall be submitted in two major subdivisions: Technical Proposal whose content and arrangement shall be as described in the articled, "INSTRUCTIONS FOR PREPARING THE TECHNICAL PROPOSAL" of this section, and a Price Proposal, which shall be prepared in detail on a basis as described and set forth in the article entitled, "INSTRUCTIONS FOR PREPARING THE PRICE PROPOSAL" of this section.
- 1.2 The Technical Proposal and the Price Proposal portions of each proposal tendered by any offeror shall each be enclosed in a separate sealed package, identified on its outer surface as to content in the manner prescribed in the article entitled "SUBMISSION OF OFFERS" of this section and submitted in the following number of copies:
 - 1.2.1 Technical Proposal One original and three (3) copies.
 - 1.2.2 Price Proposal One original and one (1) copy.
- 1.3 Each offeror may submit one or more proposals; however, each proposal shall be configured as described above, shall be considered on its own merits as to the completeness of submission and shall not share required documentation, bonding, or other requirements of submission with any other proposal submitted by the same offeror.
- 2. INSTRUCTIONS FOR PREPARING THE TECHNICAL PROPOSAL (AOC) (NOV 2002)
- 2.1 The Technical Proposal shall be organized in accordance with the following format to facilitate evaluation by the Government.
- 2.2 Technical Approach. The Technical Proposal shall be subdivided into two subsections
 - 2.2.1 The Offeror shall provide a description of:
 - Factor 1 Relevant Experience
 - Factor 2 Past Performance
- 2.2.2 Relevant Experience. The Offeror shall provide a listing of projects of similar scope, size and complexity to the requirements of this project (Interior Wayfinding and American Disability signage), i.e., that involved the fabrication/construction and installation of signage on various interior wall surfaces performed by the Offeror during the last five years. Include projects where the Offeror and proposed key subcontractors/team, if applicable, worked together.
 - 2.2.3 For each project listed, provide the following:
 - 2.2.3.1 Project, location
 - 2.2.3.2 Contracting Agency/Owner
 - 2.2.3.3 Date of award and completion date(s)
 - 2.2.3.4 Contract award amount/final amount
 - 2.2.3.5 Key personnel/subcontractors involved
 - 2.2.3.6 Brief description of project
 - 2.2.3.7 Point of Contact at agency/owner and phone number

- 2.2.3.8 Photographs of the signs constructed for the project
- 2.2.4 Past Performance. The past performance of the Offeror (relevance of this experience to this project) and the proposed key subconsultants will be evaluated to determine the extent of successful completion of projects, performed within the past five years, of similar scope, size and complexity to the requirements of this project. Proposed subconsultants will be evaluated to determine if their qualifications are sufficient to carry out their portion of the work efficiently and effectively to the highest level of professional quality.
- 2.2.4.1 The evaluation of past performance will be based in part on client references with regard to factors including, but not limited to: the offeror's record of conforming to contract requirements and to standards of good workmanship; the offeror's record of forecasting and controlling costs; the offeror's adherence to contract schedules, including the administrative aspects of performance; the offeror's history of reasonable and cooperative behavior and commitment to customer satisfaction; and generally, the offeror's business-like concern for the interest of the customer.
- 2.2.4.2 Offerors will be given an opportunity to address especially unfavorable reports of past performance, and the offeror's response, or lack thereof, will be taken into consideration. In investigating the offeror's past performance, the Government will consider references submitted by the offeror and may consider information from other sources.
- 3. INSTRUCTIONS FOR PREPARING THE PRICE PROPOSAL (AOC) (JUN 2003)
- 3.1 A firm fixed unit price shall be entered by each offeror on the Schedule page for each line item (0001AA through 0005BK) which shall represent the cost for performing the work required by this Request for Proposal. The Architect reserves the right to request from each offeror information regarding the breakdown of all costs that are included in these prices and any task orders issued against this contract, to include copies of all work sheets used in forming the proposed pricing. Erasures or other changes on any or all submissions shall be initialed by the signer of the proposal or by his duly authorized agent.
- 3.2 In addition, the Representations and Certifications, with applicable information included in the spaces provided shall be included as a part of the Price Proposal.
- 3.3 The Price Proposal will be submitted with the required documents in the following order:
 - 3.3.1 "SOLICITATION, OFFER, AND AWARD" form (original signature required in Block 15);
 - 3.3.2 The "SCHEDULE" pages; Section B;
 - 3.3.3 the "REPRESENTATIONS AND CERTIFICATIONS".

4. AOC52.215-2 INTERPRETATIONS AND AMENDMENTS (JUN 2004)

- (a) Any prospective offeror desiring an explanation or interpretation of the solicitation, drawings, specifications, etc., must request it in writing no later than fourteen calendar days prior to the date established for receipt of offers. Oral explanations or instructions given before the award of a contract will not be binding.
- (b) Prospective offerors shall request the Contracting Officer, in writing, via FAX or e-mail for an

interpretation or correction of any ambiguity, inconsistency, or error in the contract documents which they may discover or which should have been discovered by a reasonably prudent offeror. Such requests or objections to materials or methods of construction shown or specified shall be directed to the attention of the Contracting Officer at least 10 (10) calendar days prior to the date specified for receipt of proposals. Written requests shall be transmitted via e-mail to jfriedho@aoc.gov or via facsimile to (202) 225-3221.

- (c) Any interpretations or corrections, as well as any additional modifications the Contracting Officer may desire to include, will be in the form of amendments, in writing, which will be sent on the same date to all offerors if that information is necessary in submitting offers or if the lack of it would be prejudicial to other prospective offerors and shall become a part of any subsequent contract. The Contracting Officer reserves the right to answer only such questions as have, in his opinion, a definite bearing upon the proposals to be submitted.
 - (1) Offerors shall acknowledge the receipt of all amendments to the solicitation by:
 - (i) Signing and returning the amendment;
- (ii) Identifying the amendment number and date in the space provided for this purpose on the form for submitting a offer;
 - (iii) Letter or telegram; or
 - (iv) Facsimile, if facsimile offers are authorized in the solicitation.
- (2) The Government must receive the acknowledgment by the time and at the place specified for receipt of offers.
- (d) Requests for oral interpretations or any other interpretations not made by amendments will not be accepted, and any information that may possibly be gained by offerors in that manner is gratuitous and not binding.
- (e) If this solicitation is amended, all terms and conditions that are not amended remain unchanged. (End of provision)

5. AOC52.215-3 RESTRICTION ON DISCLOSURE AND USE OF DATA (JUN 2004)

Offerors that include in their proposals data that they do not want disclosed to the public for any purpose, or used by the Government except for evaluation purposes, shall—

(a) Mark the title page with the following legend:

"This proposal includes data that shall not be disclosed outside the Government and shall not be duplicated, used, or disclosed--in whole or in part--for any purpose other than to evaluate this proposal. If, however, a contract is awarded to this offeror as a result of--or in connection with--

the submission of this data, the Government shall have the right to duplicate, use, or disclose the data to the extent provided in the resulting contract. This restriction does not limit the Government's right to use information contained in this data if it is obtained from another source without restriction. The data subject to this restriction are contained in sheets (insert numbers or other identification of sheets)"; and

(b) Mark each sheet of data it wishes to restrict with the following legend:
 "Use or disclosure of data contained on this sheet is subject to the restriction on the title page of this proposal."
 (End of provision)

6. FAR 52.216-1 TYPE OF CONTRACT (APR 1984)

The Government contemplates award of a firm-fixed-price contract resulting from this solicitation.

(End of provision)

END OF SECTION L

SECTION M EVALUATION FACTORS FOR AWARD

1. EVALUATION CRITERIA (AOC) (NOV 1999)

- 1.1 General Requirements. The evaluation criteria to be used by the Contracting Officer for the selection of a contractor to perform the work specified herein are defined below. The criteria are divided into Technical and Price categories. The Technical Evaluation Criteria, when combined are significantly more important than price. However, as the difference in technical merit between the proposals becomes less significant, the relative importance of the proposed prices will increase.
- 1.1.1 Technical Evaluation Criteria. The criteria to be used in assessing the quality of each proposal are listed below. For purposes of the evaluation, Past Performance is considered equal in importance to the Technical/Experience Factors and when considered together are more important that cost/Price.

1.1.1.1 Relevant Experience

1.1.1.1 The offeror's and proposed key subcontractor's experience standard is supported when the offeror has successfully completed 3 projects that are similar in scope and nature to the scope of this contract. Offerors possessing five or more years of experience working with projects of this type may receive a more favorable rating. The degree of comparability of the offerors' projects to the project covered by this solicitation will be determined based on their relative size, scope, complexity, and the existence of characteristics identified in the Section 10430, and Section 10431 Quality Finishes and Quality Assurance for a wide variety of sign required by the Architects of the Capitol.

1.1.1.2 Past Performance

- 1.1.1.2.1 The Government shall evaluate the business practices and quality of the offeror's past performance based upon performing work on buildings of historical significance. The assessment of the offeror's past performance will be used as a means of evaluating the relative capability of the offeror to the other competitors.
 - 1.1.1.2.2 The Government will use references provided in response to Factor 1 above and may use other references, to verify past performance.
 - 1.1.1.2.3 Evaluation of past performance will be a subjective assessment based upon a consideration of all relevant facts and circumstances. The Government is seeking to determine whether the offeror has consistently demonstrated a commitment to customer satisfaction and timely delivery of services at fair and reasonable prices. The offeror and its proposed major subcontractor(s) are required to show a satisfactory record of completing contracts within budget, a satisfactory record of adhering to contract schedules, and a satisfactory history of reasonable and cooperative behavior and commitment to customer satisfaction; and evidence of a business-like concern for the interests of the customer. Offerors will be given an opportunity to address especially unfavorable reports of past performance, and the offeror's response, or lack thereof, will be taken into consideration. In investigating the offeror's past performance, the Government will consider references submitted by the offeror and may consider information from other sources.
 - 1.1.1.2.4 The Government's conclusions about the overall quality of the offeror's past performance will be highly influential in determining the relative merits of the offeror's proposal and in selecting the offers

considered most advantageous to the Government. Past performance findings will be used to validate proposals against established evaluation criteria and assign an overall risk to the Government for successful performance.

1.1.2 Price Evaluation Criteria.

- 1.1.2.1 Price criterion measure not only actual dollars but also analyze the reasonableness of the Offeror's proposed price. Price will be evaluated to determine whether it is reasonable and its position in the range of all prices..
- 1.1.2.2 As noted above, the technical criteria are considered by the Contracting Officer to be significantly more important than the proposed price. However, as the difference in technical merit between proposals becomes less significant, the relative important of price will increase.
- 1.1.2.3 It is intended that the contractor's unit prices cited in the Price Schedule, Bid Items 0001AA through 0005BK constitute proposed maximum unit prices for use on this contract. Therefore, the contractor agrees that the maximum unit prices which may be charged on any effort performed on this contract, i.e., Task Order or modification thereof, are those unit prices proposed on the Price Schedule.

2. AOC52.215-5 CONTRACT AWARD - SOURCE SELECTION PROCEDURES (JUN 2004)

- (a) The Government will award a contract resulting from this solicitation to the responsible offeror whose offer conforming to the solicitation will be most advantageous to the Government, cost or price and other factors, specified elsewhere in this solicitation, considered.
- (b) The Government may-
 - (1) Reject any or all offers if such action is in the public interest;
 - (2) Accept other than the lowest offer; and
 - (3) Waive informalities and minor irregularities in offers received.
- (c) The Government intends to evaluate proposals and award a contract without discussions with offerors (except clarifications as described in FAR 15.306(a)). Therefore, the offeror's initial proposal should contain the offeror's best terms from a price and technical standpoint. The Government reserves the right to conduct discussions if the Contracting Officer later determines them to be necessary. If the Contracting Officer determines that the number of proposals that would otherwise be in the competitive range exceeds the number at which an efficient competition can be conducted, the Contracting Officer may limit the number of proposals in the competitive range to the greatest number that will permit an efficient competition among the most highly rated proposals.
- (d) The Government may accept any item or combination of items, unless doing so is precluded by a restrictive limitation in the solicitation or the offer.
- (e) A written award or acceptance of offer mailed or otherwise furnished to the successful offeror within the time for acceptance specified in the offer shall result in a binding contract without further action by either party. Before the offer's specified expiration time, the Government may accept an

offer (or part of an offer as provided in Paragraph (d) of this provision), whether or not there are negotiations after its receipt, unless a written notice of withdrawal is received before award. Negotiations conducted after receipt of an offer do not constitute a rejection or counteroffer by the Government.

- (f) Neither financial data submitted with an offer, nor representations concerning facilities or financing, will form a part of the resulting contract. However, if the resulting contract contains a clause providing for price reduction for defective cost or pricing data, the contract price will be subject to reduction if cost or pricing data furnished is incomplete, inaccurate, or not current.
- (g) The Government may determine that an offer is unacceptable if the prices proposed are materially unbalanced between line items or sub line items. Unbalanced pricing exists when, despite an acceptable total evaluated price, the price of one or more contract line items is significantly overstated or understated as indicated by the application of cost or price analysis techniques. A proposal may be rejected if the Contracting Officer determines that the lack of balance poses an unacceptable risk to the Government.

(End of provision)

3. AOC52.217-1 EVALUATION OF OPTIONS (NOV 2003)

Except when it is determined not to be in the Government's best interest, the Government will evaluate offers for award purposes by adding the total price for the selected options which include Line Items 0002AA to 0005BK to the total price which includes the lump sum price, the line item pricing and the unit pricing. The estimated quantities given under the unit prices are for informational purposes only to provide the Government a price for evaluation purposes. Evaluation of options will not obligate the Government to exercise the options. (End of provision)

END OF SECTION M

DIVISION 1 - GENERAL REQUIREMENTS

PART 1 - GENERAL

1.1 DESCRIPTION OF REQUIREMENTS:

- A. General Requirements: The provisions or requirements of Division-1 apply to entire work of Contract and, where so indicated, to other elements which are included in project, and include, but are not limited to the following:
 - 1. Summary of the Work.
 - 2. Project Coordination.
 - 3. Definitions and Standards.
 - 4. Schedules and Reports.
 - 5. Submittals.
 - 6. Temporary Facilities and Controls.
 - 7. Products.
 - 8. Project Closeout.

1.2 **SUMMARY OF THE WORK**:

A. Project/Work Identification:

- 1. **General**: Project name is the INDEFINITE DELIVERY INDEFINITE QUANTITY (IDIQ) CONTRACT FOR INTERIOR WAYFINDING AND ADA SIGNAGE, as shown on Contract Documents prepared by the Architect of the Capitol (AOC). Drawings and specifications are dated JUNE 14, 2006.
- 2. **Summary by Reference**: Work of the Contract can be summarized by references to the SOLICITATION RFP060141 for Official Procedure for Making Changes in Contracts, Specification Sections, Drawings, Addenda and Modifications to the contract documents issued subsequent to the initial printing of this Project Manual and including, but not necessarily limited to, printed material referenced by any of these.
- 3. **Abbreviated Written Summary**: Briefly and without force and effect upon the contract documents, the work of the Contract can be summarized as follows:
 - a. The work includes fabrication, construction, and labor for the installation of interior signage for the Capitol, Senate and House Office Buildings as described in plan options below. Additional Buildings within Capitol Complex may be added. Task Order No. 1 will be for Senate-Hart Office building and are reflected in the scope of work contract documents in this set.
 - **Plan Description A**. The work includes fabrication, construction, and labor for the installation of interior signage. Under Plan Description A, the work includes fabrication and/or installation on various interior wall surfaces. Application should be specialized to accommodate all while not unnecessarily &/or permanently damaging the wall surface. See phasing plan description, this section A.6.
 - **Plan Description B**. The work includes fabrication and delivery only of interior signage. Acceptance procedures and delivery to each individual building.
 - b. Unit prices for individual sign types for a one year base contract and up to 4 option years.

- **c.** Artwork will be provided for sign types F, G, D, and E, in an electronic format to the successful offeror.
- **d.** Artwork will be provided for the 50 state seals and U. S. Territories.
- 4. Informational Drawings: Drawings indicated are For Information Only and are included for convenience with the Contract Documents and are NOT Construction Documents. These drawings contain information requested by the AOC for the use of the Architect and other consultants to the AOC. The Contractor is expected to independently verify all information shown and provide his own surveys, testing, and verification of conditions shown therein
- 5. **Use of the Contract Documents:** The Contract Documents are comprised of the Drawings (produced by several disciplines), the Specifications, the Amendments, the Contract, approved Changes and other directives. These documents are not to be used separately for bid or construction as they represent the entirety of the project. The Contractor is responsible for insuring that the documents are used together.
- 6. Phasing Plan: A phasing plan is required by building, by floor and if directed by the Architect, by sign type for both fabrication/delivery only task orders and for full installation task orders. For full installation task orders, the Contractor is expected to complete all work sequentially to provide the minimum disruption of parking, normal building operations in the area and minimal noise disturbance, while Members are in their offices and in session. The Contractor will provide his own plan for approval by the Architect showing proposed and most efficient sequencing of the work and coordination with Government parking requirements. Noise factor while Members are in session is a consideration in planning the installation phases of work. Noise factor coordination with the AOC is a requirement, which the Contractor must comply. Phasing plan will be coordinated with and submitted with the progress schedule and progress schedule updates.

B. Contractor Use of Premises:

- 1. **General**: The Contractor shall limit his use of the premises to the work indicated, so as to allow for the Government's occupancy and use by the public.
- 2. Contractor Use of the Existing Building: During the construction period the site and the building will be occupied by Members of Congress, other Government employees and the general public. Maintain the existing building in a safe and weather-tight condition throughout the construction period. Repair damage caused by construction operations. Take all precautions necessary to protect the building and its occupants during the construction period. Cooperate fully with the Architect or his representative during construction operations to minimize conflicts and to facilitate Government usage.
 - a. Clear Passage: Keep public areas such as hallways, stairs, elevator lobbies and toilet rooms free from accumulation of waste material, rubbish or construction debris.
 - b. **Smoking or open fires** will not be permitted within the building enclosure or on the premises.
 - c. **Temporary Elevator Use**: The Architect will designate elevators available for use of Contractor's personnel. Use of other than designated elevators will not be permitted.
- 3. **Limitations on Use of the Site**: Limitations on site usage as well as specific requirements that impact site utilization are indicated on the Drawings and by other Contract Documents. Portions of the site beyond areas on which work is indicated are not to be

disturbed. In addition to these limitations and requirements, administer allocation of available space among entities needing both access and space so as to produce the best overall efficiency in performance of the total work of the project. Schedule deliveries so as to minimize space and time requirements for storage of materials and equipment on site.

- a. Unless designated for sole Contractor use, keep existing driveways and entrances serving the premises clear and available to the Government and its employees at all times. Do not permit trucks of any kind to use existing sidewalks without prior authorization of the Architect.
- b. **Maintain driveways** between and around combustible material storage piles at least 15' wide and free of accumulation of rubbish, equipment and materials. Maintain access for fire fighting equipment.
- c. **Do not unreasonably** encumber the site with materials or equipment. Confine stockpiling of materials and location of storage sheds to the areas indicated. If additional storage is necessary, obtain and pay for such storage off-site.
- d. **Provide 24hr/7day** access to the building by emergency vehicles and firefighting equipment.
- 4. **Construction Parking Control**: Parking space for personal vehicles is not available on the site. Obtain approval of Architect for parking of construction motor vehicles or other equipment on the site.
- D. **Government Occupancy**: The Government reserves the right to place and install equipment as necessary in completed areas of the building and to occupy such areas prior to final acceptance, provided that such occupancy does not substantially interfere with completion of the work. Such placing of equipment and partial occupancy shall not constitute acceptance of the work or any part of the work.
- E. **Protection of Government Property**: The Contractor is expected to take all reasonable precautions to protect U.S. Government Property. In the event of damage to or theft of Government Property, the Contractor will be held fully responsible for his own personnel, his subcontractor's personnel and their actions.
- F. **Blasting**: The use of any kind or type of explosive in the performance of the work is prohibited, except the use of construction tools actuated by or employing powder-actuated charges which shall be permitted, provided that the tool is of the kind and design ordinarily used for such construction and that the Architect has authorized its use after determining that its use will not endanger human life or safety.
- G. Mechanical/Electrical Requirements of General Work: Except as otherwise indicated, comply with applicable provisions of The National Electrical Code (NEC) and standards by National Electrical Manufacturer's Association (NEMA) for electrical components of general work. Where applicable, provide products listed and labeled by nationally recognized independent testing and labeling organizations.

1.3 **PROJECT COORDINATION**:

A. Coordination and Meetings: Prepare a written memorandum on required coordination activities. Include such items as required notices, reports and attendance at meetings. Distribute this memorandum to each entity performing work at the project site. Prepare similar memorandum for separate contractors where interfacing of their work is required.

- 1. The Contractor shall provide a full time on site superintendent during all installation of work. Continuously coordinate the work of subcontractors to ensure proper processing and progress of the work. Require each subcontractor to examine work of other trades and all sections of specifications to assure satisfactory installation of, and connection between, his work and work of other trades.
 - a. **Provide other parties**, to the extent their work is affected by this work, all information necessary for the proper execution of their work. Arrange and conduct work so that other parties may complete their work at the site according to schedule. All work under this contract shall be carefully coordinated with work under other such contracts.
- 2. **The Contractor** shall maintain a complete set of Contract Documents on the site during the execution of this contract. All Drawings and Specifications shall be posted with the latest information and Changes.
- B. **Surveys and Records/Reports**: Working from lines and levels established by the property survey, establish and maintain benchmarks and other dependable markers. Establish bench marks and markers to set lines and levels for work at each story of construction and elsewhere as needed to properly locate each element of the project. Calculate and measure required dimensions as shown within recognized tolerances. Drawings shall not be scaled to determine dimensions. Advise entities performing work of marked lines and levels provided for their use. Advise Architect promptly upon detection of deviations that exceed indicated tolerances.

C. General Installation Provisions:

- Pre-Installation Meetings: Hold a pre-installation meeting at the project site well before
 installation of each unit of work which requires coordination with other work. Installer
 and representatives of the manufacturers and fabricators who are involved in or affected by
 that unit of work, and with its coordination or integration with other work that has
 preceded or will follow, shall attend this meeting. Advise Architect of scheduled meeting
 dates.
- 2. **Installer's Inspection of Conditions**: Require the Installer of each major unit of work to inspect the substrate to receive work and conditions under which the work is to be performed. The Installer shall report all unsatisfactory conditions in writing to the Contractor. Do not proceed with the work until unsatisfactory conditions have been corrected in a manner acceptable to the Installer.
- 3. **Manufacturer's Instructions**: Where installations include manufactured products, comply with the manufacturer's applicable instructions and recommendations for installation, to the extent that these instructions and recommendations are more explicit or more stringent than requirements indicated in the Contract Documents.
- 4. **Mounting Heights**: Where mounting heights are not indicated, mount individual units of work at industry recognized standard mounting heights for the particular application indicated. Refer questionable mounting height choices to the Architect for final decision.
 - a. **Mount units of work** required to be accessible to handicapped people at heights prescribed by the Uniform Federal Accessibility Standards as referenced by the Americans with Disabilities Act (ADA) (Fed. Reg./Vol. 56, No. 144/Part 36).
- D. Cleaning and Protection: During handling and installation of work at the project site, clean and protect work in progress and adjoining work on the basis of continuous maintenance. Apply protective covering on installed work where it is required to ensure freedom from damage or deterioration at time of completion.

- 1. **Clean and perform maintenance** on installed work as frequently as necessary through remainder of the construction period. Adjust and lubricate operable components to ensure operability without damaging effects.
- 2. **Limiting Exposures of Work**: To the extent possible through reasonable control and protection methods, supervise performance of the work in such a manner and by such means which will ensure that none of the work, whether completed or in progress, will be subjected to harmful, dangerous, damaging or otherwise deleterious exposure during the construction period.
 - a. **Protect against possible damage** all sills, jambs and soffits of permanent openings used as passageways or through which materials are handled. Protect exposed corners, spandrels, projecting features and similar permanent work subject to damage. Cover and protect all prefinished work from damage by mortar, plaster, gypsum drywall compounds, paint, and other construction materials and operations. Use wheelbarrows equipped with rubber tires over permanently exposed floors and paving. Provide special protection for works of art, as prescribed in the Contract Documents.
- 3. **Load all trucks** leaving the site with earthen materials or loose debris in a manner that will prevent dropping of materials on streets. Fasten suitable tarpaulins over the load before they enter surrounding paved streets. Trucks bringing earthen materials over paved streets to the site shall be similarly covered.
- 4. Clean sidewalks and streets adjacent to site daily or more often as necessary, of debris spillage or mud/dirt tracked from loading and trucking involved in construction operations. Maintain suitable truck wheel washing installation and crew to prevent any mud from being carried onto adjacent paved streets. Conform to local regulations regarding load limits.
- E. Cutting and Patching: Where the Contractor must cut, patch, alter, add to, repair or refinish existing construction and finishes which are not to be removed, he shall leave such construction and finishes complete and in satisfactory condition. Cutting, patching, and the like shall be neatly and carefully performed, and new materials and methods shall match existing corresponding work unless otherwise indicated. Exposed patches and repairs shall be as inconspicuous as possible.
 - Construction, finishes, equipment and other items which are damaged or defaced by reason of work performed under this contract shall be restored to the satisfaction of the Architect.
- F. Conservation and Salvage: It is a requirement for supervision and administration of the work that construction operations be carried out with the maximum possible consideration given to the conservation of energy, water and materials. In addition, maximum consideration shall be given to salvaging materials and equipment involved in performance of the work but not incorporated therein. Refer to other sections for required disposition of salvage materials which are the Government's property.
 - 1. **Architect Notification**: To allow time for the Architect to observe the construction, provide a minimum of 48 hours notice of excavation work, completion of steel reinforcing, pouring of concrete, paving operations, utility work, trenching, tree removal or

- replacement, commencements of next phase of work, and other tasks to be identified by the Architect.
- 2. **Archaeological Rights**: There is a possibility that items of archaeological significance may be found during the excavation of the site. In such event, the Contractor shall stop excavation in the vicinity of the find and notify the Architect immediately; subsequent excavation work shall proceed as directed by the Architect. All items found which are considered to have archaeological significance are the property of the Government.

1.4 **DEFINITIONS AND STANDARDS**:

- A. **General**: Comply with governing regulations and the codes and standards imposed upon the work. These requirements include the obtaining of permits, licenses, inspections, releases and similar documentation, as well as payments, statements and similar requirements associated with regulations, codes and standards.
- B. **Definitions**: A substantial amount of specification language consists of definitions for terms found in other contract documents, including the drawings. (Drawings must be recognized as diagrammatic in nature and not completely descriptive of the requirements indicated thereon). Certain terms used in contract documents are defined in this article. Definitions and explanations contained in this section are not necessarily either complete or exclusive, but are general for the work to the extent that they are not stated more explicitly in another element of the contract documents.
 - 1. **Installer**: The term "installer" is defined as the entity (person or firm) engaged by the Contractor, its subcontractor or sub-subcontractor for performance of a particular unit of work at the project site, including installation, erection, application and similar required operations. It is a general requirement that such entities (installers) be expert in the operations they are engaged to perform.
 - 2. **Testing Laboratory**: The term "testing laboratory" is defined as an independent entity engaged to perform specific inspections or tests of the work, either at the project site or elsewhere, and to report, and (if required) interpret results of those inspections or tests.
 - 3. **Indicated**: The term "indicated" is a cross-reference to graphic representations, notes or schedules on drawings, to other paragraphs or schedules in the specifications, and to similar means of recording requirements in contract documents. Where terms such as "shown," "noted," "scheduled," and "specified" are used in lieu of "indicated," it is for the purpose of helping the reader locate cross-reference, and no limitation is intended except as specifically noted.
 - 4. **Furnish**: Except as otherwise defined in greater detail, the term "furnish" is used to mean supply and deliver to the project site, ready for unloading, unpacking, assembly, installation, etc., as applicable in each instance.
 - 5. **Install**: Except as otherwise defined in greater detail, the term "install" is used to describe operations at the project site including unloading, unpacking, assembly, erection, placing, anchoring, applying, working to dimension, finishing, curing, protecting, cleaning and similar operations, as applicable in each instance.
 - 6. **Provide**: Except as otherwise defined in greater detail, the term "provide" means furnish and install, complete and ready for intended use, as applicable in each instance.
 - 7. **Exposed**: The term "exposed" is defined as an item or surface, exterior or interior, which can be seen by a person outside the building or a person inside a usable space within the building during normal activity.

- a. Mechanical and electrical rooms, air handling rooms, storage rooms and penthouses shall be considered to have exposed surfaces, as shall the mechanical and electrical construction within them.
- b. The interiors of closets and alcoves shall be considered exposed surfaces, and shall be finished to match the finish of the adjoining room or space, unless another finish is otherwise indicated.
- c. The interiors of cabinets shall be considered exposed, but a finish different from that of the exterior may be permitted or required by other sections.
- 8. **Concealed**: The term "concealed" is defined as an item or space not normally seen, occupied or used by building occupants or staff, such as shafts, hoistways, tunnels, ceiling plenums, attics, and crawls spaces.
- 9. **Finished Space**: The term "finished space" is defined as space normally used by the public, building occupants or staff for primary functions of the building, but does not include mechanical, electrical and elevator equipment rooms, hoistways, tunnels or mechanical penthouses, unless otherwise indicated.
- 10. **Specialist**: The term "specialist" is defined as an individual or firm of established reputation (or, if newly organized, whose personnel have previously established a reputation in the same field), which is regularly engaged in, and which maintains a regular force of workers skilled in either (as applicable) manufacturing or fabricating items required by the contract, installing items required by the contract, or otherwise performing work required by the contract. Where the contract specification requires installation by a specialist, that term shall also be deemed to mean either the manufacturer of the item, an individual or firm licensed by the manufacturer, or an individual or firm who will perform the work under the manufacturer's direct supervision.
- C. Format and Specification Content Explanations: Bolding and underscoring: Are used strictly to assist reader of specification text in scanning text for key words (for quick recall). No emphasis on or relative importance is intended where bolding and underscoring are used. Imperative language is used generally in specifications. Except as otherwise indicated, requirements expressed imperatively are to be performed by the Contractor. For clarity of reading at certain locations, contrasting subjective language is used to describe responsibilities which must be fulfilled indirectly by Contractor, or when so noted, by others.
 - 1. Abbreviations: The language of specifications and other contract documents is of the abbreviated type in certain instances, and implies words and meanings which will be appropriately interpreted. Actual word abbreviations of a self-explanatory nature have been included in texts. Specific abbreviations have been established, principally for lengthy technical terminology and primarily in conjunction with coordination of specification requirements with titles of general standards which are frequently abbreviated. Singular words will be interpreted as plural and plural words will be interpreted as singular where applicable and where full context of the contract documents so indicates.
 - 2. Minimum Quality/Quantity: In every instance, the quality level or quantity shown or specified is intended as minimum for the work to be performed or provided. Except as otherwise specifically indicated, actual work may either comply exactly with that minimum (within specified tolerances), or may surpass the quality of that minimum within reasonable limits. In complying with requirements, indicated numeric values are either minimum or maximums as noted or as appropriate for context of requirements. Refer instances of uncertainty to the Architect for decision before proceeding.

- D. **Overlapping and Conflicting Requirements**: Where there appears to be overlapping or conflicting requirements in the drawings and specifications, refer all such questions in writing to the Architect for interpretation. Do not proceed with that portion of the work that is under question until the Architect has replied in writing. Delays necessitated by requests for interpretation shall not form the basis for a Change to the contract. The Architect's interpretation and decision shall be final. Procedures for resolving disagreements with the decision of the Architect are outlined in the General Conditions of the Contract. The order of precedence is established as follows:
 - 1. **Order of Precedence:** Any inconsistency in this solicitation or Contract shall be resolved by giving precedence in the following order:
 - a. The Schedule (excluding the specifications).
 - b. Representations and other instructions.
 - c. Contract clauses.
 - d. The Specifications.
 - e. The Drawings. Large scale drawings take precedence over small scale drawings. Do not scale drawings.
 - 2. **Industry Standards**: Where compliance with two (2) or more industry standards or sets of requirements is specified, and overlapping of those different standards or requirements establishes different or conflicting minimums or levels of quality, the most stringent requirement is intended and will be enforced, unless specifically detailed language written into contract documents clearly indicates that a less stringent requirement is to be fulfilled. Refer apparently-equal-but-different requirements, and uncertainties as to which level of quality is more stringent, to the Architect for a decision before proceeding.
 - 3. **Contractor's Options**: Except for overlapping or conflicting requirements, where more than one set of requirements are specified for a particular unit of work, Options are intended to be the Contractor's regardless of whether or not it is specifically indicated as such.
- E. **Drawing Symbols**: Except as otherwise indicated, graphic symbols used on drawings are those symbols recognized in the construction industry for purposes indicated. Where not otherwise noted, symbols are defined by "Architectural Graphic Standards", published by John Wiley & Sons, Inc., Ninth edition.
 - Mechanical/Electrical Drawings: Graphic symbols used on mechanical and electrical
 drawings are generally aligned with symbols recommended by ASHRAE. Where
 appropriate, these symbols are supplemented by more specific symbols as recommended
 by other recognized technical associations including ASME, ASPE, IEEE and similar
 organizations. Refer instances of uncertainty to the Architect for clarification before
 proceeding.
- F. **Industry Standards**: Except to the extent that more explicit or more stringent requirements are written directly into contract documents, applicable standards of the construction industry have the same force and effect (and are made a part of the contract documents by reference) as if copied directly into the contract documents, or as if published copies were bound herein, subject to the order of precedence previously stated.

- 1. **Publication Dates**: Except as otherwise indicated, where compliance with an industry standard is required, conform to the standard in effect on the date of the Invitation for Bids, or, if referred to in any Addenda, at the date of such addenda.
- 2. **Abbreviations and Names**: The following acronyms or abbreviations as referenced in contract documents are defined to mean the associated names. Both names and addresses are subject to change, and are believed to be, but are not assured to be, accurate and up-to-date as of the date of contract documents:

AIA	American Institute of Architects (The) www.aia.org	(800) 242-3837 (202) 626-7300
AISC	American Institute of Steel Construction (800) 644-2400 www.aisc.org	(312) 670-2400
ANSI	American National Standards Institute www.ansi.org	(202) 293-8020
ASHRAE	American Society of Heating, Refrigerating and (800) 527-4723 Air-Conditioning Engineers www.ashrae.org	(404) 636-8400
ASTM	ASTM International (610) 832-9585 (American Society for Testing and Materials International) www.astm.comAWS American Welding Society (800) 4 www.aws.org	443-9353 (305) 443-9353
CDA	Copper Development Association Inc. www.copper.org	(800) 232-3282 (212) 251-7200
FMG	FM Global (Formerly: FM - Factory Mutual System) www.fmglobal.com	(401) 275-3000
IEEE	Institute of Electrical and Electronics Engineers, Inc. (The) www.ieee.org	(212) 419-7900
NAAMM	National Association of Architectural Metal Manufacturers www.naamm.org	(312) 332-0405
NECA	National Electrical Contractors Association www.necanet.org	(301) 657-3110
NEMA	National Electrical Manufacturers Association www.nema.org	(703) 841-3200
NFPA	National Fire Protection Association www.nfpa.org	(800) 344-3555 (617) 770-3000
NRCA	National Roofing Contractors Association www.nrca.net	(800) 323-9545 (847) 299-9070
SMACNA	Sheet Metal and Air Conditioning Contractors'	(703) 803-2980

	www.smacna.org	
SSPC	SSPC: The Society for Protective Coatings www.sspc.org	(877) 281-7772 (412) 281-2331
UL	Underwriters Laboratories Inc. www.ul.com (847) 272-8800	(800) 704-4050
WWPA	Western Wood Products Association www.wwpa.org	(503) 224-3930

National Association

G. **Federal Government Agencies**: Names and titles of federal government Standard- or Specification-producing agencies are often abbreviated. The following acronyms or abbreviations referenced in the Contract Documents indicate names of Standard- or Specification-producing agencies of the federal government. Names and addresses are subject to change but are believed to be, but are not assured to be, accurate and up to date as of the date of the Contract Documents.

CFR	Code of Federal Regulations Available from Government Printing Office www.access.gpo.gov/nara/cfr	(888) 293-6498 (202) 512-1530
EPA	Environmental Protection Agency www.epa.gov	(800) 438-2474
FS	Federal Specification Available from Defense Automated Printing Service www.astimage.daps.dla.mil/online	(215) 697-6257
	Available from General Services Administration www.fss.gsa.gov/pub/fed-specs.cfm	(202) 619-8925
	Available from National Institute of Building Sciences www.nibs.org	(202) 289-7800
OSHA	Occupational Safety and Health Administration www.osha.gov	(800) 321-OSHA (6742)

1.5 **SCHEDULES & REPORTS**:

- A. **Coordination**: Coordinate both the listing and timing of reports and other activities required by provisions of this and other sections, so as to provide consistency and logical coordination between the reports. Maintain coordination and correlation between separate reports by updating at monthly or shorter time intervals. Make appropriate distribution of each report and updated report to all parties involved in the work including the Architect.
- B. **Material Schedule**: Prior to commencing work, submit for approval the names of manufacturers and the trade names or numbers of all materials proposed for use on the

project. Do not use any material until approved by the Architect. Upon request, furnish samples of materials, without cost to the Government, for examination and testing.

- 1. **Submit 3 copies** of the product-listing schedule prior to commencement of the Work. Provide a written explanation for omissions of data, and for known variations from contract requirements.
- C. **Schedule of Values:** Within thirty (30) calendar days of the date of contract award, a Schedule of Values shall be submitted. This schedule is defined as a work item by work item breakdown of cost of each definitive work activity including Contractor's markup. The Schedule of Values shall directly correlate with the Phases of Work indicated on the approved Progress Schedule specified below.
 - 1. The Grand Total of all of the Schedules shall equal Contractor's original bid.
 - 2. The proper updating of both the Schedule of Values and the Record Drawings shall be considered precedent to approval of Partial Payments.
- D. **Shop Drawing Submittal Schedule:** Within thirty (30) calendar days of the date of contract award, a Shop Drawing Submittal Schedule shall be submitted. The schedule shall indicate at a minimum, all shop drawing submittals to be made, their contents, each specification section the submittal is drawn from, the date on which it will be submitted, the expected return dates, and the subcontractor responsible for creating the submittal. The submittal will be reviewed by the Architect as the first shop drawing submittal and comments made must be acknowledged and employed in the resubmission prior to the submittal of any other shop drawing. Do not "Load" the schedule.
- E. **Progress Schedule**: Within fourteen (14) calendar days of the date of contract award, the Contractor shall prepare and submit for approval a schedule showing the order in which he proposes to perform the Work, the dates on which he will start each phase of work and the contemplated dates of completion for each phase of site. Not less than six (6) copies of this schedule shall be submitted to the Architect.
 - 1. **Cost Correlation**: Immediately below the date line at the heading of the bar-chart, provide a two item cost correlation line, indicating both "precalculated" and "actual" costs. This cost correlation line shall show dollar-volume of work performed as of the same dates used for preparation of partial payment requests. Refer to GENERAL CONDITIONS for cost reporting and payment procedures. In so far as it is practical to do so, use the same units of work in the progress schedule as indicated in the "schedule of values" required by the GENERAL CONDITIONS and further specified above.
 - 2. Schedule Updating: Following its initial approval, the project schedule shall be updated monthly for the purpose of recording and monitoring progress of the Work and establishing the values of progress payments. If the Work falls behind schedule, revise schedule and describe action to be taken to insure that work will be completed within the Contract time. Any adjustment to the Contract Time shall be made in accordance with the GENERAL CONDITIONS. For each schedule update, prepare a narrative report which shall include a description of all activities completed during the preceding month, description of progress made and planned activities listed as started but not completed on the updated Progress Schedule, and a written description and justification of any proposed revision to the logic sequence.
 - a. **Contractor Revisions**: The Contractor may also request revisions to the logic sequence and schedule of the Progress Schedule in the event that his planning for

- the project is revised. If revisions to the approved Progress Schedule are desired, the Architect shall be notified in writing for his approval, stating reasons for proposed revision. If the Architect considers such proposed revisions to be of a major nature, he may require the Contractor to revise and resubmit for approval, without additional cost to the Government, all or the affected portion of the schedule to indicate the effect on the entire project. Provide two weeks notice to the Architect, in writing, prior to submitting any Contractor proposed revisions not discussed in a previous Progress Meeting.
- b. **Architect Revisions**: Architect-directed revisions to the Progress Schedule will be forwarded to the Contractor with a ten (10) calender day Contractor response period. The Contractor shall either assent to the proposed change or state reasons for not implementing the proposed revision.
- c. **Progress Updates**: Revisions to the Progress Schedule made to reflect actual work progress to date are not revisions to logic sequence and schedule. In disagreements concerning actual progress recorded to date, the Architect's determination shall govern.
- 3. **Distribution**: Following the initial submittal to and response by the Architect, print and distribute progress schedules to the Architect (3 copies), separate contractors, the principal subcontractors and suppliers or fabricators, and others with a need-to-know schedule-compliance requirement. When revisions are made, distribute updated issues to the appropriate entities.
- F. **Progress Meetings and Documentation**: In addition to specific coordination and pre-installation meetings for each element of work, and other regular project meetings held for other purposes, hold a general progress meeting each month (this can be a teleconference) with time coordinated with preparation of the partial payment request. Require each entity then involved in planning, coordination or performance of work to be properly represented at each meeting. Discuss status of each element of current work in relation to Progress Schedule. Determine how behind-schedule work will be expedited, and secure commitments from entities involved in doing so to ensure that work will be completed within Contract Time.
 - Initial Progress Meeting: Schedule initial progress meeting, recognized as "Pre-Construction Meeting", for a date not more than 15 days after date of commencement of the Work. Use it as an organizational meeting, and review responsibilities and personnel assignments.
 - 2. **Daily Reports**: Prepare a daily report, recording information concerning events at the site; and submit duplicate copies to Architect on at least weekly intervals.
- G. **Permits, Licenses, and Certificates**: For the Government's records, submit copies of utility permits, licenses, certifications, utility inspection reports, releases, notices, receipts for fee payments, judgments, and similar documents, correspondence and records established in conjunction with compliance with standards and regulations bearing upon performance of the Work.

1.6 **SUBMITTALS**:

A. **General**: Shop drawings, product data, samples and other work-related submittals are required to amplify, expand and coordinate the information contained in the Contract Documents. The Contractor is responsible for all dimensions, for the design of adequate or proper components, connections and other items, for the inclusion in the work of all elements

and incidental details, and for the satisfactory fabrication, construction, operation and coordination of the work.

- 1. **Approval** of any submission shall not be construed as a complete or precise check of the item submitted but will only indicate that the general methods of design, detailing, construction or other elements under consideration appear to be satisfactory, without specific determinations or particulars.
- 2. **Changes to the Contract** will not be made by notations on submittals. In the event submittals returned by the Architect with notations, which in the opinion of the Contractor, constitute additional work for which he is entitled to an adjustment in the contract sum or the contract time, the Contractor shall comply with the procedure set forth in Article, "Changes," of the GENERAL CONDITIONS.
- 3. **Do not permit** submittal copies without an appropriate final "Action" marking by the Architect to be used in connection with the work.
- 4. **Submissions of "Approved Equals:"** In addition to standard submittal requirements, for each item submitted as an "approved equal" submit the following:
 - a. Comparison of proposed approved equal's characteristics with the salient characteristics of the specified product demonstrating that the proposed approved equal fully meets or exceeds the specifications,
 - b. Drawings and samples as required for specified products,
 - c. Any changes required in other elements (if any) because of the submission of the proposed approved equal, and
 - d. A listing of sources of supply, maintenance service (if applicable), and replacement parts.
- B. **Submittal Procedures**: Make all submittals to the Architect or to an individual designated by the Architect.
 - 1. **Only the Architect** or an individual designated by the Architect can approve or disapprove submittals. Deviations and variations from the contract requirements contained in the submittal can be approved only by the Architect or by an individual delegated such authority by the Architect.
 - 2. **Costs** associated with transmittal of submittals shall be borne by the Contractor.
 - 3. **Review Time**: Except as specified elsewhere, allow for a review period of thirty (30) calendar days after receipt of the submittals by the Architect. Advise the Architect on each submittal, as to whether processing time is critical to the progress of the work, and if work would be expedited if processing time could be shortened. No extension of time will be authorized because of the Contractor's failure to transmit submittals or resubmittals to the Architect sufficiently in advance of the work. For submittals of items requiring coordination between different trades or subcontractors, review time period starts from the time that all required submittals have been received by the Architect and ends when submittal leaves the Architect. The Contractor is required to coordinate all work involving associated sub-trades and produce coordinated drawings for submittal where required by individual specification sections or as required below.
 - 4. **Preparation of Submittals**: Provide permanent marking on each submittal to identify project, date, Contractor, subcontractor, supplier, manufacturer, submittal name and similar information to distinguish it from other submittals. Label as to number and title of specification section, drawing number and detail references, as appropriate. Show Contractor's executed review and approval marking and provide space of not less than 20 sq. in. for the Architect's "Action" marking. Package each submittal appropriately

- for transmittal and handling. Submittals which are received from sources other than through the Contractor's office will be returned without action.
- 5. **Number of Copies**: Submit a minimum of four (4) copies of each submittal requested.
- C. **Specific Submittal Requirements**: Specific submittal requirements for individual units of work are specified in the applicable specification section. Except as otherwise indicated in the individual specification sections, comply with the requirements specified herein for each type of transmittal.
 - Product Data: Collect required product data into a single submittal for each unit of
 work or system. Mark each copy to show which choices and options are applicable to
 the project. Where product data has been printed to include information on several
 similar products, some of which are not required for use on the project, or are not
 included in this submittal, mark the copies to show clearly that such information is not
 applicable.
 - a. **Submittals**: Submittal is for information and record, unless otherwise indicated. Initial submittal is final submittal unless returned by the Architect, marked with an action which indicates an observed non-compliance.
 - 1) **Initial Submittal**: Except as otherwise indicated, submit three (6) copies of each required product data submittal, plus two (2) additional copies where required for maintenance manuals. The Architect will retain five (5) copies and return the other marked with "Action" and corrections or modifications as required.
 - 2. **Shop Drawings**: Provide special notation of dimensions that have been established by field measurement. Highlight, encircle or otherwise indicate deviations from the Contract Documents on the shop drawings.
 - a. **Preparation**: Submit newly prepared information, drawn to accurate scale on sheets not less than 8-1/2" x 11"; except for actual pattern or template type drawings, the maximum sheet size shall not exceed 36" x 48". Indicate the name of the firm that prepared each shop drawing and provide appropriate project identification in the title block.
 - 1) Do not reproduce contract documents or copy standard printed information as the basis of shop drawings.
 - 2) Use standard architectural scales for all drawings..
 - b. Coordination Drawings: Prior to installation of sleeves and inserts for equipment, and/or the performance of work in spaces in which two or more trades are involved and in which the probability of interference exists as determined by either the Contractor or the Architect, submit composite coordination drawings for the Work. Show sequencing and relationship of separate units of work which must interface in a restricted manner to fit in the space provided, or function as indicated. In case interference develops, the Architect will decide which work shall be relocated, regardless of which was installed first. Coordination drawings are considered shop drawings and must be definitive in nature.

- c. **Equipment and Systems**: Shop Drawings for equipment and systems shall show ratings (where applicable), and how components are assembled, function together, and how they will be installed. Shop drawings, product data, certificate of conformance or compliance, certified test or inspection reports, and other submittals for equipment, systems, and their component parts shall be coordinated and submitted as a unit. Multiple or piecemeal submissions are not acceptable except where prior approval is obtained from the Architect, in which case a list of data to be submitted later shall be included with the first submission.
- d. **Initial Submittal**: One correctable 1-1/2 mil translucent polyester reproducible print and one blue-line or black-line; reproducible will be returned..
- e. **Final Submittal**: 3 prints, plus 2 additional prints where required for maintenance manuals; 2 will be retained and remainder will be returned, one of which is to be marked-up and maintained by Contractor as "Record Document."
- 3. **Samples**: Documentation required specifically for sample submittals includes a generic description of the sample, the sample source or the product name or manufacturer, compliance with governing regulations and recognized standards. In addition, indicate limitations in availability, sizes, delivery time, and similar limiting characteristics.
 - a. Preparation: Where possible provide samples that are physically identical with the proposed material or product to be incorporated in the work; provide full scale, fully fabricated samples cured and finished in the manner specified. Where variations in color, pattern, or texture are inherent in the material or product represented by the sample, submit not less than 3 units of the sample, which show the full range of variations. Where samples are specified for the Architect's selection of color, texture or pattern, submit a full set of available choices for the material or product. Mount, display, or package samples in the manner specified to facilitate the review of indicated qualities. Prepare samples to match the Architect's sample where so indicated.
 - b. **Submittal**: Submit 3 sets of samples in the final submittal, one set will be returned. If the submittal is for the Architect's selection of color, pattern, texture or similar characteristics from a manufacturer's standard range of choices, only a single set of samples is required for a preliminary submittal. The final submittal may then be limited only to those choices selected by the Architect for final incorporation into the Work.
 - c. **Mock-Ups** and similar samples specified in individual work sections are special types of samples. Comply with sample submittal requirements to the fullest extent possible. Process transmittal forms to provide a record of activity. All mock-up samples of sign types are the property of the Architect.

4. Miscellaneous Submittals:

- a. **Inspection and Test Reports**: Classify each inspection and test report as being either "shop drawings" or "product data" depending on whether the report is specially prepared for the project, or a standard publication of workmanship control testing at the point of production. Process inspection and test reports accordingly.
- b. **Offsite Fabrication Facilities**: Provide for scheduled visits to off site fabrication facilities by the Architect. Make all facilities, including storage areas

- and plant, open and accessible to review of procedures, materials used and storage and shipping methods.
- c. **Warranties**: Refer to Article "Products" for specific general requirements on warranties, product bonds, workmanship bonds and maintenance agreements. In addition to copies desired for the Contractor's use, furnish 2 executed copies of such warranties, bonds or agreements. Provide 2 additional copies where required for maintenance manuals.
- d. Staging Plan: The Architect has indicated in plan where the Contractor can stage the construction. Submit a Staging Plan indicating specific locations of the superintendent's trailer, storage and loading of materials, security perimeter for staging area, locations of informational construction signage, and resources and any other construction facilities required.
- 5. **Closeout Submittals**: Refer to Article "Project Closeout" and to individual sections of these specifications for specific submittal requirements of project closeout information, materials, tools, and similar items.
- D. **Architect's Action**: Except for submittals for the record and similar purposes, where action and return on submittals is required or requested, the Architect will review each submittal and mark with appropriate "Action." Where the submittal must be held for coordination, the Architect will so advise the Contractor without delay.
 - 1. **If no changes** to the drawing are required, three (3) prints and the reproducible drawing will be returned to the Contractor, bearing the stamp of the Architect, stating "APPROVED."
 - 2. **If changes** to the drawing are required, but are of such minor nature that fabrication and/or construction can proceed in accordance with the correction noted by the Architect without resubmission of the drawing three (3) prints and the reproducible drawing will be returned to the Contractor bearing the Stamp of the Architect stating "Approved as Noted." The Contractor shall proceed with fabrication and/or construction in accordance with the Architect's corrections, and resubmit corrected copy for the Architect's records.
 - 3. **If changes** to the drawing are required, but are of such nature that fabrication or construction cannot proceed, three (3) prints and the reproducible drawing will be returned to the Contractor, bearing the stamp of the Architect stating "Revise and Resubmit." In such a case, the Contractor shall resubmit the drawings, properly corrected. Upon resubmission of shop drawings, if any corrections or changes are made other than those marked by the Architect, the Contractor shall clearly indicate any such corrections or changes made on his own initiative.
 - 4. **If the product does not meet** the specification requirements, the number of copies outlined above will be returned to the Contractor, bearing the stamp of the Architect stating "REJECTED." In such a case, the Contractor shall submit a new product which complies with the technical specifications.
 - 5. **Other Action**: Where the submittal is returned, marked with the Architect's explanation, for special processing or other Contractor activity, or is primarily for information or record purposes, the submittal will be marked as follows:
 - Not Subject to Review: This review category will apply to submittals which are not required by the Contract Documents and are inadvertently submitted and stamped; or
 - b. **Received/No Action Required**: This category will be used when returning "Informational Submittals" for which the Architect is not required to take action.

1.7 TEMPORARY FACILITIES AND CONTROLS:

- A. **Description of Requirements**: This article specifies administrative and procedural requirements for temporary services and facilities, including such items as temporary utility services, temporary construction and support facilities, and project security and protection.
 - Use Charges: No cost or usage charges for temporary services or facilities are chargeable to the Government. Cost or use charges for temporary services or facilities will not be accepted as a basis of claims for a change-order extra. All materials and equipment provided by the Contractor for temporary facilities shall remain the property of the Contractor.
 - 2. **Materials and Execution**: Provide new materials and equipment for temporary services and facilities; used materials and equipment that are undamaged and in serviceable condition may be used, if acceptable to the Architect. Provide only materials and equipment that are recognized as being suitable for the intended use, by compliance with appropriate standards. Do not use materials of temporary service in permanent installation.
- B. **Quality Assurance**: Comply with the requirements of the District of Columbia Building Code and regulations governing construction and local industry standards, in the installation and maintenance of temporary services and facilities.
 - Standards: Comply with the requirements of NFPA Code 241, "Building Construction and Demolition Operations", the ANSI-A10 Series standards for "Safety Requirements for Construction and Demolition", and the NECA National Joint Guideline NJC-6 "Temporary Job Utilities and Services".
 - a. **Refer** to "Guidelines for Bid Conditions for Temporary Job Utilities and Services", as prepared jointly by Associated General Contractors of America (AGC) and American Specialty Contractors, Inc. (ASC) for industry recommendations.
 - b. **Trade Jurisdictions**: The assigned responsibilities for the installation and operation of temporary utilities are not intended to interfere with the normal application of trade regulations and union jurisdictions applicable to the work.
 - 2. **Inspections**: Inspect and test each service before placing temporary utilities in use. Arrange for required inspections and tests by governing authorities, and obtain required certifications and permits for use.
- C. Job Conditions: Provide each temporary service and facility ready for use at each location when the service or facility is first needed to avoid delay in performance of the Work. Maintain, expand as required and modify temporary services and facilities as needed throughout the progress of the Work. Do not remove until services or facilities are no longer needed, or are replaced by the authorized use of completed permanent facilities.

D. Temporary Utilities:

1. **Temporary Telephones**: Contractor's superintendent(s) are required to have cell phone(s).

- 6. **Temporary Sanitary Facilities**: Use of the designated existing Government toilet facilities, will be permitted, at the discretion of each Jurisdiction's Superintendent. Do not clean tools or equipment in building toilet rooms.
- 5. **Temporary Partitions:** Erect and maintain dustproof partitions and temporary enclosures to limit dust and dirt migration and to separate areas from fumes and noise.
- 6. **Construction Aids**: Design, construct, and maintain construction aids and miscellaneous general services and facilities as needed to accommodate performance of the work. Construction aids and miscellaneous general services and facilities include, but are not limited to the following:
 - a. Provide temporary stairs where ladders are not adequate for performance of work, and until permanent stairs are available. Cover finished permanent stairs which will be exposed to occupants' use, with a durable protective covering of plywood or similar material so that finishes will be undamaged at the time of acceptance.
 - b. **Provide scaffolds** as required for proper execution of the Work. Remove or relocate scaffolds promptly to avoid interference with other trades. Provide stairs for vertical circulation.
 - c. **Provide adequate guardrails and barriers** at perimeters of each level of construction as work progresses in accordance with District of Columbia requirements and in conformance with requirements of the Special Conditions.
 - d. **Provide adequate facilities** for hoisting materials and employees. Do not permit employees to ride hoists which comply only with requirements for hoisting materials. The Contractor is responsible for selection of type, size and number of facilities. Truck cranes and similar devices used for hoisting are considered as being "tools and equipment" and not temporary facilities.
 - e. **Chutes**: Do not permit free dropping of materials, rubbish or debris, but remove by use of material hoist and/or rubbish chute. Locations of all hoists and chutes are subject to approval by the Architect.
 - 1. Protect building from use of hoists and chutes to prevent damage, marring or staining of permanent work. Brace and guy securely and provide safety devices as required by code.
- 7. **Project Signage**: No signs, other than safety signs, may be erected on the site unless specifically indicated otherwise.
- F. **Security and Protection Facilities**: Provide and maintain all necessary barricades, lights, and other safeguards for the protection of Members of Congress, Government employees, Contractor's employees and the general public from injury. Protect materials and work on the site, whether incorporated in the work or not, against damage or loss from any cause.
 - 2. **Provide a reasonably neat** and uniform appearance in security and protection facilities acceptable to the Architect.
 - 3. **Barricades and Fences**: Comply with recognized standards and code requirements for the erection of substantial, structurally adequate barricades where needed to prevent accidents and losses. Paint with appropriate colors, graphics and warning signs to inform personnel at the site and the public, of the hazard being protected against.

G. Temporary Controls:

- 1. Traffic Control: Plan vehicular access methods, locations and timing of deliveries in a manner to minimize interference with street and pedestrian traffic and to conform to District of Columbia regulations. Do not block or obstruct public streets, driveways and walkways adjacent to the site at any time during performance of the work without proper authorization. Do not permit trucks of any kind to use existing sidewalks without prior authorization of the Architect.
- 2. **Collection and Disposal of Wastes**: Establish a system for daily collection and disposal of waste materials from construction areas on the site/premises. Enforce requirements strictly.
- 3. **Dust Control**: During periods of construction activity creating dust conditions sprinkle periodically the site areas disturbed by Contractor's operation or treat with dust suppressors to control dust. Dry power brooming will not be permitted. Use vacuuming, wet mopping, wet sweeping or wet power brooming. Air blowing will be permitted only for cleaning non-particulate debris. Use only wet cutting procedures for unit masonry and concrete.
- 5. **Noise Control**: Avoid the use of tools and equipment that produce harmful noise. Restrict the use of noise making tools and equipment to hours of use that will minimize noise complaints from persons or firms near the project site.

1.8 **PRODUCTS**:

- A. General: Refer to clause, "Materials and Workmanship," of the GENERAL CONDITIONS. After execution of the Contract, the Contractor's requests for changes in the products, materials, equipment and methods of construction required by the Contract Documents are considered requests for "contract modifications," and are subject to the requirements specified in Architect of the Capitol, "Official Procedure for Making Changes in Contracts." Revisions to the contract documents, where requested by the Architect are considered as "changes" not substitutions.
- B. Quality Assurance: Compatibility of products is a basic requirement of product selection. When the Contractor is given the option of selecting between two or more products for use on the project, the product selected must be compatible with other products previously selected, even if the products previously selected were also Contractor options. The complete compatibility between various choices available to the Contractor is not assured by the various requirements of the Contract Documents, but must be provided by the Contractor. Provide a single product for each required product selection, regardless of whether that product selection is provided by more than one sub-contractor. Do not alter product brands or series for a given product selection during the life of the contract without written approval of the Architect.
 - 1. **Source Limitations**: To the fullest extent possible and subject to the restrictions of the "Buy American Act," provide products of the same generic kind, from a single source, for each unit of work.
- C. **Product Delivery, Storage, and Handling**: Deliver, store, and handle products in accordance with manufacturer's recommendations, using means and methods that will prevent damage, deterioration and loss, including theft. Control delivery schedules to minimize

long-term storage at the site and to prevent overcrowding of construction spaces, and to ensure minimum holding or storage times for items known or recognized to be flammable, hazardous, easily damaged, or sensitive to deterioration or loss.

- 1. **Deliver products** to the site in the manufacturer's sealed container or other packaging system, complete with labels and instructions for handling, storing, unpacking, protecting, ventilating, and installing.
- 2. **Store products** at the site in a manner that will facilitate inspection and measurement of quantity or counting of units, and in conformance with manufacturer's instructions.
- 3. **Store heavy materials** away from the project structure in a manner that will not endanger the supporting construction.
- D. **General Product Compliance**: Requirements for individual products are indicated in the Contract Documents; compliance with these requirements is in itself a contract requirement. These requirements may be specified in any one of several different specifying methods, or in any combination of these methods.
 - Procedures for Selecting Products: The Contractor's options in selecting products are limited by requirements of the Contract Documents and governing regulations. They are not controlled by industry traditions or procedures experienced by the Contractor on previous construction projects.
 - a. **Performance Specification Requirements**: Where the specifications require compliance with indicated performance requirements, provide products that comply with the specific performance requirements indicated, and that are recommended by the manufacturer for the application indicated. The manufacturer's recommendations may be contained in published product literature, or by the manufacturer's individual certification of performance. General overall performance of a product is implied where the product is specified for specific performances.
 - b. **Compliance with Standards, Codes and Regulations**: Where the specifications require only compliance with an imposed standard, code or regulation, the Contractor has the option of selecting a product that complies with specification requirements, including the standards, codes and regulations.
 - c. Visual Matching: Where matching an established sample is required, the final judgement of whether a product proposed by the Contractor matches the sample satisfactorily will be determined by the Architect. Where there is no product that matches the sample satisfactorily and also complies with other specified requirements, comply with the provisions of the contract documents concerning "contract modifications" for the selection of a matching product in another product category, or for non-compliance with specified requirements.
 - d. Visual Selection: Except as otherwise indicated, where specified product requirements include the phrase "...as selected from the manufacturer's standard colors, patterns, textures..." or similar phrases, the Contractor has the option of selecting the product and manufacturer, provided the selection complies with other specified requirements. The Architect is subsequently responsible for selecting the final color, pattern and texture from the product line selected by the Contractor.
- E. **General Product Requirements**: Provide products that comply with the requirements of the contract documents and that are undamaged and, unless otherwise indicated, unused at the time of installation. Provide products that are complete with all accessories, trim, finish,

safety guards and other devices and details needed for a complete installation and for the intended use and effect.

- 1. **Provide products** that are essentially the standard catalogued products of manufacturers regularly engaged in production of such products and that are the manufacturer's latest standard design that complies with the specification requirements. Equipment shall essentially duplicate items that have been in satisfactory commercial and industrial use at least two years, or more if otherwise specified, prior to bid opening; or in lieu thereof shall have been used and operated in a test installation which, in the opinion of the Architect, duplicate its field performance for the same period of time. The Architect reserves the right to require the Contractor to submit evidence to this effect for his approval. When two units of the same class of equipment are required, these units shall be the product of a single manufacturer; however, the component parts of the system need not be the products of the same manufacturer.
- 2. **Provide standard**, domestically produced products for which the manufacturer has published assurances that the products and its parts are likely to be available to the Government at a later date.
- 3. **Nameplates**: Except as otherwise indicated for required labels and operating data, do not permanently attach or imprint manufacturer's or producer's nameplates or trademarks on exposed surfaces of products which will be exposed to view either in occupied spaces or on the exterior of the completed project.
- F. **Installation of Products**: Except as otherwise indicated in individual sections of these specifications, comply with the manufacturer's instructions and recommendations for installation of the products in the applications indicated. Anchor each product securely in place, accurately located and aligned with other work. Clean exposed surfaces and protect surfaces as necessary to ensure freedom from damage and deterioration at time of acceptance.

1.9 **PROJECT CLOSEOUT**:

- A. **Definitions**: "Project Closeout" is the term used to describe certain collective project requirements, indicating completion of the work that are to be fulfilled near the end of the Contract Time in preparation for final acceptance and occupancy of the Work by the Government, as well as final payment to the Contractor and the normal termination of the Contract.
 - 1. **Time of closeout** is directly related to "Final Acceptance." Therefore, the time of closeout may be either a single time period for the entire Work or a series of time periods for individual elements of the Work that have been certified as substantially complete at different dates. This time variation, if any, shall be applicable to the other provisions of this Division.
- B. **Final Cleaning**: Special cleaning requirements for specific units of Work are included in the appropriate sections of Division 2 through 16. General Cleaning during the regular progress of the Work is required by the GENERAL CONDITIONS and is included under Article "Temporary Facilities and Controls".
 - 1. **Cleaning**: Provide final cleaning of the Work at the time indicated. Employ experienced workers or professional cleaners for final cleaning. Clean each surface or unit of work to the condition expected from a normal, commercial building cleaning and maintenance program. Comply with the manufacturer's instructions for operations.

- a. **Complete the following** cleaning operations before requesting the Architect's inspection for Final Acceptance.
- b. **Remove labels** which are not required as permanent labels.
- c. Clean transparent materials, including mirrors and glass in doors and windows, to a polished condition. Remove putty and other substances which are noticeable as vision-obscuring materials. Replace chipped or broken glass and other damaged transparent materials.
- d. **Clean exposed** exterior and interior hard-surfaced finishes to a dust-free condition, free of dust, stains, films and similar noticeable distracting substances. Restore reflective surfaces to their original reflective condition. Leave concrete floors broom clean. Vacuum carpeted surfaces.
- e. **Wipe surfaces** of mechanical and electrical equipment clean. Remove excess lubrication and other substances. Clean plumbing fixtures to a sanitary condition. Clean light fixtures and lamps.
- f. Clean the project site, including landscape development areas, of rubbish, litter and other foreign substances. Sweep paved areas to a broom clean condition; remove stains, spills and other foreign deposits. Rake grounds that are neither paved nor planted, to a smooth even-textured surface.
- 2. **Pest Control**: Engage an experienced exterminator to make a final inspection of the project, and to rid the project of rodents, insects and other pests.
- 3. **Compliance**: Comply with safety standards and governing regulations for cleaning operations. Remove waste materials from the site and dispose of in a lawful manner.
 - a. Where extra materials of value remaining after completion of associated work have become the Government's property, salvage or dispose of these materials to the Government's best advantage as directed.
- C. Record Document Submittals: Specific requirements for record documents are indicated in the individual sections of these specifications. Other requirements are indicated in the GENERAL CONDITIONS. General submittal requirements are indicated in the various "Submittals" articles of individual sections of the Project Manual.
 - 1. **Do not use** record documents for construction purposes; protect from deterioration and loss in a secure, fire-resistive location; provide access to record documents for the Architect's reference during normal working hours.
 - 2. Record Documents: Maintain a record set of blue or black line white-prints of contract drawings and shop drawings in a clean, undamaged condition. Mark-up the set of record documents to show the actual installation where the installed work varies substantially from the work as originally shown. Mark whichever drawing is most capable of showing the actual "field" condition ("as-built" condition) fully and accurately; however, where shop drawings are used for mark-up, record a cross-reference at the corresponding location on the working drawings. Give particular attention to concealed work that would be difficult to measure and record at a later date.
 - a. **Mark record sets** with red erasable pencil and, where feasible, use other colors to distinguish between variations in separate categories of work.
 - b. **Note related** change-order numbers where applicable.
 - c. Organize record drawing sheets into manageable sets, bind with durable paper cover sheets, and print suitable titles, dates and other identification on the cover of each set.

- d. **Materials and Tools**: Refer to individual sections of the Project Manual for required quantities of spare parts, extra and overrun stock, maintenance tools and devices, keys, and similar physical units to be submitted.
- D. **Maintenance Manuals**: Organize operating and maintenance data into suitable sets of manageable size. Bind data into individual binders properly identified and indexed. Bind each set of data in a heavy-duty 2-inch, 3-ring vinyl-covered binder, with pocket folders for folded sheet information. Mark the appropriate identification on both front and spline of each binder.
- E. **Warranties and Bonds:** At Final Completion compile two copies of each required warranty and bond properly executed by the Contractor, or by the Contractor, subcontractor, supplier, or manufacturer. Organize the warranty documents into an orderly sequence based on the table of contents of the Project Manual.
 - 1. Bind warranties and bonds in heavy-duty, commercial quality, durable 3-ring vinyl covered loose-leaf binders, thickness as necessary to accommodate contents, and sized to receive 8-1/2" by 11" paper.
 - a. Provide heavy paper dividers with celluloid covered tabs for each separate warranty. Mark the tab to identify the product or installation. Provide a typed description of the product or installation, including the name of the product, and the name, address and telephone number of the installer.
 - b. Identify each binder on the front and the spine with the typed or printed title "WARRANTIES AND BONDS," the Project title or name, project number, and the name of the Contractor.
 - 2. When operating and maintenance manuals are required for warranted construction, provide additional copies of each required warranty, as necessary, for inclusion in each required manual.
- F. General Operating and Maintenance Instructions: Arrange for each installer of operating equipment and other work that requires regular or continuing maintenance, to meet at the site with the Government's personnel to provide necessary basic instruction in the proper operation and maintenance of the entire Work. Where installers are not experienced in the required procedures, include instruction by the manufacturer's representatives.
- G. Closeout Submittals: Prior to requesting Final Inspection, submit the following:
 - 1. Project Record Documents, properly annotated and in the format required.
 - 2. Copies of Warranties and Bonds.
 - 3. Operation and Maintenance data.
 - 4. All required operating or special tools required in individual sections.
 - 5. All required keys and keying schedules.
- H. **Prerequisites to Final Acceptance**: Complete the following before requesting the Architect's final inspection for certification of final acceptance, and final payment as required by the GENERAL CONDITIONS. List known exceptions, if any, in the request.
 - 1. **Submit the final payment** request with final releases and supporting documentation not previously submitted and accepted. Include certificates of insurance for products and completed operations where required.
 - 2. **Submit an updated final statement**, accounting for final additional changes to the Contract Sum.

- 3. **Submit a certified copy** of the Architect's final punch-list of itemized work identified to be completed or corrected, stating that each item has been completed or otherwise resolved for acceptance and has been endorsed and dated by the Architect.
- 4. **Submit final meter readings for utilities**, a measured record of stored fuel, and similar data either as of the date of substantial completion, or else when the Government took possession of and responsibility for corresponding elements of the Work.
- 5. **Submit** consent of surety.
- I. Reinspection Procedures: The Architect will reinspect the Work upon receipt of the Contractor's notice that the work, including punchlist items resulting from earlier inspections, has been completed, except for these items whose completion has been delayed because of circumstances that are acceptable to the Architect.
- J. **Removal of Protection**: Except as otherwise indicated or requested by the Architect, remove temporary protection devices and facilities which were installed during the course of the work to protect previously completed work during the remainder of the construction period.

END OF DIVISION 1

PART 1 - GENERAL

1.1 RELATED DOCUMENTS

A. Drawings and general provisions of the Contract, including General and Supplementary Conditions and Division 1 Specification Sections, apply to this Section.

1.2 SUMMARY

- A. This Section includes the following:
 - 1. Nonilluminated changeable graphic directories.
- B. Related Sections include the following:
 - 1. Division 10 Section "Signs" for panel-sign-type directories

1.3 SUBMITTALS

- A. Product Data: Include construction details, material descriptions, dimensions of individual components and profiles, and finishes for directories.
- B. Shop Drawings: Include plans, elevations, sections, details, and attachments to other work.
 - 1. For installed products indicated to comply with design loads, include structural analysis data signed and sealed by the qualified professional engineer responsible for their preparation.
- C. Samples for Initial Selection: For each type of sign material indicated that involves color selection.
- D. Samples for Verification: For the directory, include the following Samples to verify color selected:
 - 1. Full-size Sample required.
 - 2. Four (4) process plotted color print.
 - 3. Approved samples will remain with AOC as control sample comparison for signage installation.
- E. Qualification Data: For Installer.
- F. Maintenance Data: For signage cleaning and maintenance requirements to include in maintenance manuals.
- G. Warranty: Special warranty specified in this Section.

1.4 QUALITY ASSURANCE

- A. Installer Qualifications: An authorized representative of directory manufacturer for installation and maintenance of units required for this Project.
- B. Source Limitations: Obtain directories through one source from a single manufacturer.

- C. Product Options: Information on Drawings and in Specifications establishes requirements for directories' aesthetic effects and performance characteristics. Aesthetic effects are indicated by dimensions, arrangements, alignment, and profiles of components and assemblies as they relate to sightlines, to one another, and to adjoining construction. Performance characteristics are indicated by criteria subject to verification by one or more methods including field testing and in-service performance.
- D. Product Options: Drawings indicate size, profiles, and dimensional requirements of directories and are based on the specific system indicated. Refer to Division 1 Section "General Requirements."
 - 1. Do not modify intended aesthetic effects, as judged solely by Architect, except with Architect's approval. If modifications are proposed, submit comprehensive explanatory data to Architect for review.
- E. Pre-installation Conference: Conduct conference at Project site to comply with requirements in Division 1 Section "General Requirements."

1.5 PROJECT CONDITIONS

- A. Field Measurements: Verify recessed openings by field measurements before fabrication and indicate measurements on Shop Drawings.
 - 1. Established Dimensions: Where field measurements cannot be made without delaying the Work, establish opening dimensions and proceed with fabricating directories without field measurements. Coordinate wall construction to ensure that actual opening dimensions correspond to established dimensions.

WARRANTY

- B. Special Warranty: Manufacturer's standard form in which manufacturer agrees to repair or replace components of directories that fail in materials or workmanship within specified warranty period.
 - 1. Failures include, but are not limited to, the following:
 - a. Structural failures of cabinets or frames.
 - b. Faulty operation of hardware or illumination system.
 - c. Deterioration of metals, metal finishes, and other materials beyond normal weathering.
 - 2. Warranty Period: Five years from date of Substantial Completion.

PART 2 - PRODUCTS

2.1 MATERIALS

- A. Aluminum: Alloy and temper recommended by aluminum producer and manufacturer for type of use and finish indicated, and as follows:
 - 1. Sheet: ASTM B 209 (ASTM B 209M).

- 2. Extruded Shapes: ASTM B 221 (ASTM B 221M), Alloy 6063.
- B. Bronze Castings: ASTM B 584, alloy UNS No. C83600 (No. 1 manganese bronze).
- C. Clear Acrylic Sheet: ASTM D 4802, Category A-1 (cell-cast sheet), with Finish 1 (smooth or polished), and 6 mm thick, unless otherwise indicated; colorless sheet with visible light transmittance of 92 percent measured per ASTM D 1003.
- D. PVC: Extruded, high-impact PVC plastic with painted finish.
- E. Unframed Panel: Fabricate signs with edges mechanically and smoothly finished to comply with the following requirements:
 - 1. Edge Condition: Square Cut.
 - 2. Corner Condition: Square.
- F. Frames: Fabricate frames to profile indicated; comply with the following requirements for materials and corner conditions:
 - 1. Material: Aluminum and Bronze either Cast or Extruded.
 - 2. Corner Condition: Square.
- G. Laminated Panels: Permanently laminate face panels to backing sheets of material; use manufacturer's standard process.
- H. Graphic Content and Style: Provide sign copy that complies with requirements indicated in the Sign Schedule for size, style, spacing, content, mounting height and location, material, finishes, and colors of signage.
- Brackets: Fabricate brackets and fittings for bracket-mounted signs from extruded aluminum to suit panel sign construction and mounting conditions indicated. Factory-paint brackets in color matching Architect's sample.
- J. Fasteners: Provide screws, bolts, and other fastening devices made from same material as items being fastened, except provide hot-dip galvanized, stainless-steel, or aluminum fasteners for exterior applications. Provide types, sizes, and lengths to suit installation conditions. Use security fasteners where exposed to view.

2.2 CHANGEABLE GRAPHIC DIRECTORIES

- A. Nonilluminated, Changeable Graphic Directory:
 - 1. Refer to the Design Intent Drawings and notes provided by The Douglas|Group for the AOC. Manufactured or custom fabricated directories may be used if in compliance with design and technical requirements identified on the drawings and in this section.
 - 2. Case Frame: Removable, clear acrylic sheet and changeable graphic panel held in place by clips, backer panel and the reveal frame.
 - a. Hinge Location: Side.

3. Bronze Frame: Permanently mount to case frame using a hidden method of attachment.

2.3 FABRICATION

- A. Fabricate directories to requirements indicated for dimensions, design, and thickness and finish of materials. Use metals and shapes of thickness and reinforcing to produce flat surfaces, free of oil canning, and to impart strength for size, design, and application indicated.
- B. Fabricate directory cabinets and door frames with reinforced corners, mitered and welded to a hairline fit, with no exposed fasteners. Provide structural reinforcement to prevent racking and misalignment.

2.4 FINISHES, GENERAL

- A. Comply with NAAMM's "Metal Finishes Manual for Architectural and Metal Products" for recommendations for applying and designating finishes.
- B. Protect mechanical finishes on exposed surfaces from damage by applying a strippable, temporary protective covering before shipping.
- C. Appearance of Finished Work: Variations in appearance of abutting or adjacent pieces are acceptable if they are within one-half of the range of approved Samples. Noticeable variations in the same piece are not acceptable. Variations in appearance of other components are acceptable if they are within the range of approved Samples and are assembled or installed to minimize contrast.

2.5 ALUMINUM FINISHES

- A. Finish designations prefixed by AA comply with the system established by the Aluminum Association for designating aluminum finishes.
- B. Class I, Clear Anodic Finish: AA-M12C22A41 (Mechanical Finish: nonspecular as fabricated; Chemical Finish: etched, medium matte; Anodic Coating: Architectural Class I, clear coating 0.018 mm or thicker) complying with AAMA 611.

2.6 COPPER-ALLOY FINISHES

- A. Finish designations prefixed by CDA comply with the system established by the Copper Development Association for designating copper-alloy finish systems, as defined in NAAMM's "Metal Finishes Manual for Architectural and Metal Products."
- B. Medium-Satin Finish: CDA M32 (Mechanical Finish: directionally textured, medium satin).

PART 3 - EXECUTION

3.1 EXAMINATION

- A. Examine walls, with Installer present, for compliance with requirements for installation tolerances, surface conditions of wall, and other conditions affecting performance of work.
 - 1. For the record, prepare written report, endorsed by Installer, listing conditions detrimental to performance of work.
- B. Examine roughing-in for electrical power system to verify actual locations of connections before installation of illuminated directories.

- C. Examine walls and partitions for proper backing for directories.
- C. Examine walls and partitions for suitable framing depth where recessed directories will be installed.
- D. Proceed with installation only after unsatisfactory conditions have been corrected.

3.2 PREPARATION

A. Prepare recesses for directories as required by type and size of unit.

3.3 INSTALLATION

- A. General: Install directories in locations and at mounting heights indicated on Drawings, or if not indicated, at heights indicated below. Keep perimeter lines straight, level, and plumb. Provide grounds, clips, backing materials, adhesives, brackets, anchors, trim, and accessories necessary for complete installation.
 - 1. Mounting Height: 60 inches above finished floor to center of directory.
- B. Recessed Directories: Attach directories to wall framing with fasteners at 16 inches (400 mm) o.c. Attach aluminum trim over edges of recessed directories and conceal grounds and clips.
- C. Surface-Mounted Directories: Attach directories to wall surfaces with concealed clips, hangers, or grounds fastened at not less than 16 inches (400 mm) o.c. Secure both top and bottom of directories to walls.
- D. Freestanding Directories: Install directories in locations indicated. Adjust floor glides so directories are level and plumb.

3.4 ADJUSTING AND CLEANING

- A. Adjust directory doors to operate smoothly without warp or bind and contact points meet accurately. Lubricate operating hardware as recommended by manufacturer.
- B. Touch up factory-applied finishes to restore damaged or soiled areas.

END OF SECTION 10430

SECTION 10431 - SIGNS SPECIFICATIONS

PART 1 - GENERAL

1.1 RELATED DOCUMENTS

A. Drawings and general provisions of the Contract, including General and Supplementary Conditions and Division 1 Specification Sections, apply to this Section.

1.2 SUMMARY

- A. This Section includes the following:
 - 1. Panel signs.
 - 2. Cast-metal plaques.
 - 3. Signage accessories.
- B. Related Sections include the following:
 - 1. Division 10 Section "Directories" for building directories.

1.3 SUBMITTALS

- A. Product Data: Include construction details, material descriptions, dimensions of individual components and profiles, and finishes for each type of sign.
- B. Shop Drawings: Include plans, elevations, and large-scale sections of typical members and other components. Show mounting methods, grounds, mounting heights, layout, spacing, reinforcement, accessories, and installation details.
 - 1. Provide message list for each sign, including details of wording, lettering, symbols and Braille layout.
- C. Samples for Initial Selection: For each type of sign material indicated that involves color selection.
- D. Samples for Verification: For each type of sign, include the following Samples to verify color selected:
 - 1. Panel Signs: Full-size Samples of each type of sign required.
 - 2. Casting: Show representative texture, character style, spacing, finish, and method of attachment.
 - 3. Approved samples will be returned for installation into Project if approved.
- E. Qualification Data: For Installer.

F. Maintenance Data: For signage cleaning and maintenance requirements to include in maintenance manuals.

1.4 QUALITY ASSURANCE

- A. Installer Qualifications: An authorized representative of signage manufacturer for installation and maintenance of units required for this Project.
- B. Source Limitations: Obtain each sign type through one source from a single manufacturer.
- C. Regulatory Requirements: Comply with the Americans with Disabilities Act (ADA) and with code provisions as adopted by authorities having jurisdiction.
 - 1. Interior Code Signage: Provide signage as required by accessibility regulations and requirements of authorities having jurisdiction. These include, but are not limited to, the following:
 - a. Elevator Signs: Life Safety Code 2003 Edition
 - b. Stairway Identification: Life Safety Code 2003 Edition
 - c. Signs for Accessible Spaces: ADAG.
- D. Electrical Components, Devices, and Accessories: Listed and labeled as defined in IBC 2003, IEC 2003 and NFPA 101 (2003), by a testing agency acceptable to authorities having jurisdiction, and marked for intended use.

1.5 PROJECT CONDITIONS

A. Field Measurements: Where sizes of signs are determined by dimensions of surfaces on which they are installed, verify dimensions by field measurement before fabrication and indicate measurements on Shop Drawings.

1.6 COORDINATION

- A. For signs supported by or anchored to permanent construction, advise installers of anchorage devices about specific requirements for placement of anchorage devices and similar items to be used for attaching signs.
 - 1. For signs supported by or anchored to permanent construction, furnish templates for installation of anchorage devices.
- B. Coordinate location of remote transformers with building construction. Ensure that transformers are accessible after completion of Work.

PART 2- PRODUCTS

2.1 PANEL SIGNS

A. General: Provide panel signs that comply with requirements indicated for materials, thicknesses, finishes, colors, designs, shapes, sizes, and details of construction.

- 1. Produce smooth panel sign surfaces constructed to remain flat under installed conditions within tolerance of plus or minus 1/16 inch (1.5 mm) measured diagonally.
- B. Refer to the Design Intent Drawings and notes provided by The Douglas|Group for the AOC. Manufactured or custom-fabricated signs may be used if in compliance with design and technical requirements identified on the drawings and in this section.
- C. Cast-Acrylic Sheet: Manufacturer's standard and as follows:
 - 1. Color: As selected by Architect from manufacturer's full range.
- D. Aluminum Sheet and Plate: ASTM B 209 (ASTM B 209M), alloy and temper recommended by aluminum producer and finisher for type of use and finish indicated, and with not less than the strength and durability properties of 5005-H15.
- E. Phenolic-Backed Photopolymer Sheet: Provide light-sensitive, water-wash photopolymer face layer bonded to a phenolic base layer to produce a composite sheet with a Type D Shore durometer hardness of 80.
- F. PVC: Extruded, high-impact PVC plastic with painted finish.
- G. Unframed Panel Signs: Fabricate signs with edges mechanically and smoothly finished to comply with the following requirements:
 - 1. Edge Condition: Square Cut.
 - 2. Corner Condition: Square.
- H. Frames: Fabricate frames to profile indicated; comply with the following requirements for materials and corner conditions:
 - 1. Material: Aluminum and Bronze either Cast or Extruded.
 - 2. Corner Condition: Square.
- I. Laminated Panels: Permanently laminate face panels to backing sheets of material; use manufacturer's standard process.
- J. Brackets: Fabricate brackets and fittings for bracket-mounted signs from extruded aluminum to suit panel sign construction and mounting conditions indicated. Factory-paint brackets in color matching Architect's sample.
- K. Graphic Content and Style: Provide sign copy that complies with requirements indicated in the Sign Schedule for size, style, spacing, content, mounting height and location, material, finishes, and colors of signage.
- L. Tactile and Braille Copy: Manufacturer's standard process for producing copy complying with ADA Accessibility Guidelines and ICC/ANSI A117.1. Text shall be accompanied by Grade 2 braille. Produce precisely formed characters with square cut edges free from burrs and cut marks.
 - 1. Panel Material: Photopolymer.

- 2. Raised-Copy Thickness: Not less than 1/32 inch (0.8 mm).
- M. Subsurface Copy: Apply minimum 4-mil- (0.10-mm-) thick vinyl copy to back face of clear acrylic sheet forming panel face to produce precisely formed opaque image. Image shall be free from rough edges.
- N. Applied Copy: Die-cut characters from vinyl film of nominal thickness of 3 mils (0.076 mm) with pressure-sensitive adhesive backing. Apply copy to exposed face of panel sign.
 - 1. Panel Material: Opaque Acrylic or Painted Aluminum Panel.
- O. Colored Coatings for Acrylic Sheet: For copy, background and frame colors, provide Pantone Matching System (PMS) colored coatings, including inks and paints, that are recommended by acrylic manufacturers for optimum adherence to acrylic surface and are nonfading for application intended.

2.2 CAST-METAL PLAQUES

- A. General: Provide castings free from pits, scale, sand holes, and other defects. Comply with requirements specified for metal, border style, background texture, and finish and in required thickness, size, shape, and copy.
- B. Manufactures must have current seal graphics on all 50 states, District of Columbia and territories on file for use in this project.
- C. Aluminum Castings: Provide aluminum castings of alloy and temper recommended by sign manufacturer for casting process used and for use and finish indicated.
- D. Bronze Castings: ASTM B 584, alloy UNS No. C83600 (No. 1 manganese bronze).
- E. Border Style: Raised flat band.
- F. Background Texture: Manufacturer's standard leatherette finish.
- G. Mounting: Concealed studs for substrates encountered.

2.3 PANEL SIGN TYPES

A. Room Signs:

- 1. Material: Photopolymer, Plastic Sheet, Aluminum, Brass and Bronze.
- 2. Perimeter: Framed.
- 3. Copy: Surface Tactile and Braille.
- 4. Character Style: Garamond Family.
- 5. Text: As indicated in the Sign Schedule.
- 6. Message: Changeable and Fixed.
- 7. Sizes:
 - a. Sign: Sizes as indicated on Design Drawings.

AOC Project No. 950141 (June 2006) RFP060141

b. Character: Sizes as indicated on Design Drawings.

8. Colors:

- a. Frame: Bronze and Aluminum.
- b. Character: As indicated on Design Drawings.
- c. Background: AOC Brown.

B. Toilet Room Signs:

- 1. Material: Photopolymer, Plastic Sheet, Aluminum, Brass and Bronze.
- 2. Perimeter: Framed.
- 3. Copy: Surface Tactile and Braille.
- 4. Character Style: Garamond Family.
- 5. Text: As indicated in the Sign Schedule.
- 6. Message: Changeable and Fixed.
- 7. Sizes:
 - a. Sign: Sizes as indicated on Design Drawings.
 - b. Character: Sizes as indicated on Design Drawings.

8. Colors:

- a. Frame: Bronze and Aluminum.
- b. Character: As indicated on Design Drawings.
- c. Background: AOC Brown.

C. Wayfinding Signs:

- 1. Material: Photopolymer, Plastic Sheet, Aluminum, Brass and Bronze.
- 2. Perimeter: Framed.
- 3. Copy: Surface Tactile and Braille.
- 4. Character Style: Garamond Family.
- 5. Text: As indicated in the Sign Schedule.
- 6. Message: Changeable and Fixed.
- 7. Sizes:
 - a. Sign: Sizes as indicated on Design Drawings.
 - b. Character: Sizes as indicated on Design Drawings.

8. Colors:

- a. Frame: Bronze and Aluminum.
- b. Character: As indicated on Design Drawings.
- c. Background: AOC Brown.

2.4 ACCESSORIES

- A. Vinyl Film: Provide 3M, or equivalent, opaque non-reflective vinyl film, 0.0035-inch (0.089-mm) minimum thickness, with pressure-sensitive adhesive backing suitable for both exterior and interior applications.
- B. Mounting Methods: Use concealed fasteners, double-sided vinyl tape and silicone adhesive fabricated from materials that are not corrosive to sign material and mounting surface.

C. Anchors and Inserts: Provide nonferrous-metal or stainless steel anchors and inserts for exterior installations and elsewhere as required for corrosion resistance. Use toothed steel or lead expansion-bolt devices for drilled-in-place anchors. Furnish inserts, as required, to be set into concrete or masonry work.

2.6 FINISHES, GENERAL

- A. Comply with NAAMM's "Metal Finishes Manual for Architectural and Metal Products" for recommendations for applying and designating finishes.
- B. Protect mechanical finishes on exposed surfaces from damage by applying strippable, temporary protective covering before shipping.
- C. Appearance of Finished Work: Variations in appearance of abutting or adjacent pieces are acceptable if they are within one-half of range of approved Samples. Noticeable variations in same piece are not acceptable. Variations in appearance of other components are acceptable if they are within range of approved Samples and are assembled or installed to minimize contrast.

2.7 ALUMINUM FINISHES

- A. Clear Anodic Finish: Manufacturer's standard clear anodic coating, 0.018 mm or thicker, over a satin (directionally textured) mechanical finish.
- B. Clear Finish: Natural satin finish with clear polyurethane protective coat.
- C. Baked-Enamel Finish: Manufacturer's standard baked enamel complying with paint manufacturer's written instructions for cleaning, conversion coating, and painting.
- D. Cast-Metal Plaque Finishes:
 - 1. Raised Areas: Hand-tool and buff borders and raised copy to produce manufacturer's standard satin finish.
 - 2. Background Finish: Painted.

2.8 COPPER-ALLOY FINISHES

- A. Bronze and Brass Plate: Medium satin (directionally textured) finish.
- B. Cast-Bronze Character Finishes: Manufacturer's standard satin finish with exposed surfaces free from porosity, burrs, and rough spots; with returns finished with fine-grain air blast.
- C. Cast-Bronze Plaque Finishes: Exposed surfaces free from porosity, burrs, and rough spots; with returns finished with fine-grain air blast.
 - 1. Raised Areas: Hand-tool and buff borders and raised copy to produce manufacturer's standard satin finish.
 - 2. Background Finish: Painted.

- D. Cast-Brass Plaque Finishes: Exposed surfaces free from porosity, burrs, and rough spots; with returns finished with fine-grain air blast.
 - 1. Raised Areas: Hand-tool and buff borders and raised copy to produce manufacturer's standard satin finish.
 - 2. Background Finish: Painted.
- E. Clear Protective Coating: Coat exposed surfaces of copper alloys with manufacturer's standard clear organic coating specially designed for coating copper-alloy products.

PART 3- EXECUTION

3.1 EXAMINATION

- A. Examine substrates, areas, and conditions, with Installer present, for compliance with requirements for installation tolerances and other conditions affecting performance of work.
- B. Verify that items, including anchor inserts and electrical power, provided under other sections of Work are sized and located to accommodate signs.
- C. Examine supporting members to ensure that surfaces are at elevations indicated or required to comply with authorities having jurisdiction and are free from dirt and other deleterious matter.
- D. Proceed with installation only after unsatisfactory conditions have been corrected.

3.2 INSTALLATION

- A. General: Locate signs and accessories where indicated, using mounting methods of types described and in compliance with manufacturer's written instructions.
 - 1. Install signs level, plumb, and at heights indicated, with sign surfaces free from distortion and other defects in appearance.
 - 2. Interior Wall Signs: Install signs on walls adjacent to latch side of door where applicable. Where not indicated or possible, such as double doors, install signs on nearest adjacent walls. Locate to allow approach within 3 inches (75 mm) of sign without encountering protruding objects or standing within swing of door.
- B. Wall-Mounted Panel Signs: Attach panel signs to wall surfaces using methods indicated below:
 - 1. Vinyl-Tape Mounting: Use double-sided foam tape to mount signs to smooth, nonporous surfaces. Do not use this method for vinyl-covered or rough surfaces.
 - 2. Silicone-Adhesive Mounting: Use liquid-silicone adhesive recommended in writing by sign manufacturer to attach signs to irregular, porous, or vinyl-covered surfaces. Use double-sided vinyl tape where recommended in writing by sign manufacturer to hold sign in place until adhesive has fully cured.

- 3. Mechanical Fasteners: Use nonremovable mechanical fasteners placed through predrilled holes. Attach signs with fasteners and anchors suitable for secure attachment to substrate as recommended in writing by sign manufacturer.
- 4. Where panel signs are scheduled or indicated to be mounted on glass, provide matching plate on opposite side of glass to conceal mounting materials.
- C. Bracket-Mounted Units: Provide manufacturer's standard brackets, fittings, and hardware as appropriate for mounting signs that project at right angles from walls and ceilings. Attach brackets and fittings securely to walls and ceilings with concealed fasteners and anchoring devices to comply with manufacturer's written instructions.
- D. Cast-Metal Plaques: Mount plaques using standard fastening methods recommended in writing by manufacturer for type of wall surface indicated.
 - 1. Concealed Mounting: Mount plaques by inserting threaded studs into tapped lugs on back of plaque. Attachment method must accommodate that the plaques be removable at least once a year by AOC maintenance staff.

3.3 CLEANING AND PROTECTION

A. After installation, clean soiled sign surfaces according to manufacturer's written instructions. Protect signs from damage until acceptance by the Architect..

END OF SECTION 10431



CP-491 (4-04)

REQUEST FOR CHECK OF CRIMINAL HISTORY RECORDS

3p	cated at 499 South Capitol 3 m Monday through Friday	Street SW Washington, I for processing.	D.C., Room 127 between	the hours of 7am until	
1.	Name: (Last, First, Middle	St	ddress: reet & No.		
		Ci Zi	p:Te	ele:	
	Other Names Ever Used: (eone".)	.g. maiden name, nicknar	ne, ect. If you have neve	r used another name write	
3.	Date of Birth: (Month, Day	, Year)	4. Birthplace: (C	ity and State or Country)	
5.	Social Security Number:			6. Gender: Male Female	
7.	Race: 8. Height	9. Weight:	10. Eye Color:	11. Hair Color:	
	SIGN	NATURE AND RELEAS	SE OF INFORMATION	V:	
	READ TH	E FOLLOWING CARE	FULLY BEFORE YOU	SIGN:	
	 I understand that the information provided above will be used to check the criminal history records of the Federal Bureau of Investigation (FBI). 				
	 I consent to the use of the information provided in making a security determination concerning me. 				
	I certify that, to the be correct, and complete.	est of my knowledge and made in good faith.	belief, all of the informat	ion provided above is true,	
12.	Signature:		13. Date	:	

**** NOTICE ****

TO:

ALL VENDORS/CONTRACTORS/CONSULTANTS

FROM:

THE OFFICE OF THE ARCHITECT OF THE CAPITOL

Due to requirements set forth in the DEBT COLLECTION IMPROVEMENT ACT OF 1996 (PUBLIC LAW 104-134), all payments made to vendors, contractors and consultants doing business with the Federal Government must be made by Electronic Funds Transfer (EFT) directly to your financial institution. If you are currently enrolled under EFT with the Architect of the Capitol, no further action is necessary other than to report changes.

EFT payments are cost effective, enabling prompt, convenient and reliable payments directly to a designated bank account.

The Architect of the Capitol, in making EFT payments, supplies the financial institution with identifying information (ie. invoice number), which accompanies each transaction. The financial institution in turn can supply this information to the account holder.

Therefore, to accomplish the mandate of P. L. 104-134, it is necessary that the attached sheet; PAYMENT INFORMATION FORM ACH VENDOR PAYMENT SYSTEM be completed and returned with your bid or offer as set forth in Section G of the solicitation.

PAYMENT INFORMATION FORM ACH VENDOR PAYMENT SYSTEM

This form is used for ACH payments with an addendum record that carries payment-related information. Recipients of these payments should bring this information to the attention of their financial institution when presenting this form for completion. The information will be transmitted in the CCD+ format to the designated financial institution.

Debt Collection Improvement Act of 1996

PAPERWORK REDUCTION ACT STATEMENT

The information being collected on this form is pursuant to Public Law 104-134, which mandated Electronic Funds Transfer for recipients of all federal payments (excluding IRS tax refunds) beginning July 24, 1996. This information will be needed by the Treasury Department to transmit payments and

COI	MPANY INFORMATION	
NAME:	,	
ADDRESS: CONTRACT NUMBER: AOC	TAXPAYER IDENTIFICATION NUMBER (TIN):	
CONTACT PERSON NAME:	TELEPHONE NUMBER: () FAX NUMBER: ()	
AG	GENCY INFORMATION	
NAME: ARCHITECT OF THE CAPITOL - FORD HOU	ISE OFFICE BUILDING	
NAME: ARCHITECT OF THE CAPITOL - FORD HOC ADDRESS: ACCOUNTING DIVISION, ROOM H2-205		
WASHINGTON, D.C. 20024	FAX NUMBER: (202) 225-7321	
CONTACT PERSON NAME: MR. JAMES JARBOE	TELEPHONE NUMBER: (202) 226-2552	
FINANCIAL	INSTITUTION INFORMATION	
BANK NAME:		
BRANCH LOCATION: (If applicable)		
CONTACT NAME:	TELEPHONE NUMBER: ()	
NINE DIGIT ROUTING TRANSIT NUMBER:		
DEPOSITOR ACCOUNT NUMBER:		
TYPE OF ACCOUNT: CHECKING SAVIN	NGSLOCKBOX	
SIGNATURE AND TITLE OF REPRESENTATIVE: TELEPHONE NUMBER:		
3 3		

Architect of the Capitol Revised 06/11/99

UNITED STATES CAPITOL POLICE WASHINGTON, D.C 20510

OFF-SITE DELIVERY CENTER INSTRUCTION

All delivery vehicles will be required to report to the Off-Site Delivery Center for the U.S. Capitol Police located at 4700 Shepherd Parkway S.W., for inspection before proceeding to the Capitol Building via the North Barricade on Constitution Avenue, N.E., the loading dock of the Senate Office Buildings located on D Street, N.E., the loading dock for the Ford House Office Building on Virginia Avenue, S.W., or the Delaware Avenue, S.W., access point for the Rayburn, Longworth, and Cannon Office Buildings' loading docks.

No deliveries will be accepted unless the vehicles have been processed at the Off-Site Delivery Center. The hours of the Off-Site Delivery Center are 5:00a..m. to 2:00p.m., Monday through Friday.

In order to gain access to the loading dock for the Capitol and the House and Senate Office Buildings, you are required to have a letter on file with the United States Capitol Police. The letter must be on <u>company letterhead</u> accompanied by signature of the owner, president or manager. Please <u>print or type</u> the names in alphabetical order of persons requesting access. Requests for access must be renewed once per year and should contain the following information:

- 1. Name of the Company
- 2. Name of the Drivers/Employees Requiring Access
- 3. Social Security Number for each Driver/Employee
- Date of Birth for Each Driver/Employee
- 5. Building(s) to be Accessed
- 6. Company Contact Person and Phone Number

The above information is to be provided to:

United States Capitol Police Off-Site Delivery Center 4700 Shepherd Parkway S.W Washington, D.C. 20032 Fax: 202 226-0571

Any questions can be directed to Off-Site Delivery Center during business hours at 202 226-0905.

AOC PAST PERFORMANCE QUESTIONNAIRE RFP: 060141

IDIQ CONTRACT FOR WAYFINDING SIGNS FOR THE ARCHITECT OF THE CAPITOL

The company listed below is preparing an offer on the above project for the Architect of the Capitol, Washington, DC. Your name has been provided as a customer reference regarding performance under a past contract with your agency/company. Your comments are considered Source Selection Sensitive, therefore, you are advised that your response will be safeguarded to the extent cited in the Federal Acquisition Regulation (FAR) 42.1503. FAR prohibits the release of past performance evaluations to other than other Government personnel and the company whose performance is being evaluated during the period the information may be used to provide source selection information.

This past performance questionnaire is being submitted by the contractor and you are requested complete it and return it to the Architect of the Capitol in care of John Friedhoff at FAX number (202)225-3221, or e-mail JFRIEDHO@AOC.GOV on or before the proposal submission due date of August 30, 2006. While all elements below may not apply, please complete as much as possible.

Company/Individual Requesting Past Project I	<u>information</u> :	
Name:		
Past Project Title On Which The Company Is	Being Evaluated	
Project Title :		
Evaluator POC (for verification purposes)		
Name: Agency/Company, POC		Date:
Phone No.:	Fax No	
E-mail Address:		
Address:		
Position held or function in relation to project:		

AOC PAST PERFORMANCE QUESTIONNAIRE RFP: 060141

Ratings: Please evaluate the contractor's performance using the following ratings:

"C	O" Outstanding	The contractor's performance clearly exceeded the contract	requirements.
	"Satisfactory	The contractor's performance met the contract requirements	
"N	A" Marginal The c difficu	ontractor's performance met the minimum contract require lty.	ments but with
J"	J" Unsatisfactory	The contractor's performance was poor and/or did not requirements.	satisfy contract
Ur pe	nsatisfactory, please	ide supporting information for the following. If the rating is e provide specific contract/job performance areas which were eance with the contract's minimum requirements. (Use addit	exceeded or not
1.	Performance in m	neeting delivery/completion schedules:	
			Rating:
2.	What did the cont	ractor do to improve or resolve schedule problems, if any?	Rating:
3.	The contractor's	quality control (CQC).	
			Rating:
4.	The contractor's p	performance in delivering quality work in accordance with the	contract:
			Rating:
5.	The contractor's a	ability to provide the required work at a reasonable total price.	
			Rating:
6.	The contractor's o	compliance with labor standards, if applicable	

AOC PAST PERFORMANCE QUESTIONNAIRE RFP: 060141

	Rating:
7. The contractor's compliance with safety standards.	
	Rating:
8. Has the contractor been given any of the following: Cure notice, show cause, le suspension of payments, termination? If yes, please explain.	
	Rating:
9. Would you award another contract to this contractor? If no, please stat recommending this contractor additional work.	
	Rating:
10. Was the customer satisfied with the end product?	
	Rating:
11. The relationship between the contractor and owner's contract Officer/COR/COTR?	team/Contracting
	Rating:
12. The contractor's on-site management and coordination of subcontractors.	
	Rating:
13. The contractor's overall corporate management, integrity, reasonablenes conduct.	ss and cooperative
	Rating:

AOC PAST PERFORMANCE QUESTIONNAIRE RFP: 060141

14. Has the contractor filed any modifications? And to what extent?	
15. Has the contractor been provided an opportun	nity to discuss any negative performance ratings?
If so, what were the results?	
16. OVERALL RATING	Rating:
17. Please provide any additional comments:	

HART Senate Office Building





REVISIONS:
NO DESCRIPTION

<u>OWNER</u>

DATE

Architect of the Capitol Architecture Division Room H2-529 Ford House Office Bldg. 2nd. and D Streets S.W. Washington, D.C. 20024 TEL: 202-226-1820 FAX: 202-226-1981

ENVIRONMENTAL GRAPHIC DESIGNER

The Douglas|Group 915 Duke Street Alexandria, VA 22202 TEL: 703-549-8050 FAX: 703-549-8053

DESIGN INTENT DRAWINGS FOR SUPERINTENDENT APPROVAL

APPROVAL:

LARRY STOFFELL SUPERINTENDENT SENATE OFFICE BUILDINGS

SIGNATURE

BUILDING NAME

HART SENATE OFFICE BUILDING PROJECT TITLE

CAPITOL COMPLEX - WAYFINDING & ADA COMPLIANCE

DRAWING TITLE

SLP/Contract Documents

SCALE	DRAWN E	3Y	CHECKED BY
	SH/MB		
PROJ. NO	Э.	IFB NO.	
24512.02			
CAD FILE	NO.		
DRAWIN	G NO.		

SHEET DATE 06/14/06

Table of Contents

V - Handicap Restriction Plaque	Project InformationProjects NotesiiProject InformationiiiProject FontsivProject Graphicsv
GG - Building Announcement/Directional (Location Elevation)	
HH - Exit Information	Project Signage Sign Location Plans Hart Basement
Typical Drawings D, V & W - (10" x 8 1/2")	Hart Ground FloorSLP.GHart First FloorSLP.1Hart Second FloorSLP.2Hart Third FloorSLP.3Hart Fourth FloorSLP.4Hart Fifth FloorSLP.5Hart Sixth FloorSLP.6Hart Seventh FloorSLP.7Hart Eighth FloorSLP.8Hart Ninth FloorSLP.9
Assembly Drawings F - Floor Directory/Directional (Changeable Graphic/for Reference Only) ASSEMBLY 1 D, E, G, W & HH - Secondary Directional (Changeable Graphic/for Reference Only) ASSEMBLY 2	Project Signage A - Level Identification

T - Self-Schedule Conference Room D.18.0

Project Team Project Notes

OWNER

Architect of the Capitol U.S. Capitol Building Washington, DC 20515 202-226-1820 fax 202-226-1981 Contact: Marilyn Wong-Wittmer

SIGNAGE DESIGNER

The Douglas | Group 915 Duke Street Alexandria, VA 22314 Note: The terms Fabricator and Installer apply to any entity who performs or is awarded all or part of these functions to conform to the design documents, for this project. In some instances these terms may apply to the same entity.

GENERAL NOTES ABOUT BID SUBMITTAL

Refer to Project Manual

GENERAL NOTES FOR FABRICATION AND INSTALLATION OF THIS PROJECT

- 1. Do not scale the drawings. All sign copy should be considered to be representative and is subject to change. Refer to final message schedule for final copy on all signs.
- The contract documents are complementary, and what is required by one shall be as binding as if required by all. The Fabricator and Installer shall coordinate all required portions of work in contract scope.
- 3. Fabricator shall conform to these drawings and specifications and submit to The Douglas | Group samples for all finishes included in their scope of work before commencement of such work.
- 4. For the purpose of bidding process, proprietary names identifying items of work are used solely to describe the standard of the product or the color of the finish, unless the items of work are explicitly noted as not having an equal. Fabricator shall secure approval of any substitutions from The Douglas | Group. Any items approved for substitution should be submitted to The Douglas | Group for final approval.
- 5. All dimensions are to the exterior face of the finished material unless otherwise noted. All elevations are noted from finish floor elevations.
- 6. All dimensions of existing work and all dimensions required for work that is connected with work in place shall be verified by the Fabricator and Installer. In addition, the Fabricator shall verify all finishes and notify The Douglas | Group of any discrepancies before performing any work.
- 7. The Fabricator or Installer shall notify The Douglas | Group of any discrepancies in the fabrication documents immediately and shall not proceed or allow sub-fabricators to work in those areas until said discrepancies are resolved.
- 8. When changes are required, for any reason, notify The Douglas | Group before performing any work. Changes which alter the contract documents must have the approval of The Douglas | Group and Architect before commencement of such work. Changes which modify the contract amount must have the approval of The Douglas | Group and Owner before commencement of such work.

- 9. All graphics and colors provided must conform to scale, specifications, and PMS numbers where provided.
- 10. All work shall be done in accordance with all applicable codes and to the highest standards of trade practice.
- 11. Prior to commencing any work, the Fabricator or Installer who is awarded all or part of fabrication and/or installation shall review with the Owner, Architect and The Douglas | Group the phasing of their work and secure approval from all parties. Submit to the Architect and The Douglas | Group a master schedule of the awarded work one (1) week after the contract signing.
- 12. All interior finish and trim materials are to meet Class III flame spread ratings of 76 to 200, as per applicable code.
- 13. Fabricator and Installer is responsible for obtaining and paying for all applicable permits and certificates required of their work.
- 14. The Fabricator shall warrant that all merchandise is free of defects in material or workmanship and shall provide Owner with a warranty to replace or repair any merchandise that fails to conform to above for a period of no less than one (1) year from date of final acceptance.
- 15. The Installer shall provide and install adequate blocking for all wall hung and wall supported items except for those items which are hung from items not in contract.
- 16. The Installer shall patch and repair all existing surfaces as required prior to applying new finishes. All openings, voids, or unfinished surfaces created by removal or alteration of existing work, shall be closed or patched and finished as necessary to match existing continuous surfaces or new finishes required.
- 17. All hangers, channels, rods and other misc. support steel shall be installed by the installer as necessary for the support of suspended equipment (signage) and shall be fastened to the existing structure in such a manner as to not compromise its existing structural integrity or fire rating.
- 18. The Installer shall keep the site work area(s) clear of unnecessary debris; and shall keep all work area(s) secured when unattended for the duration of the installation period.
- 19. The Installer shall clean the site of all unnecessary debris and clean all glass, chrome, and any other items before vacating the site and final Owner sign-off.
- 20. The fabricator shall provide all engineering required for exterior signage guaranteed for local conditions.
- 21. Fabricator is responsible for removal and wall preparation at all existing signage locations.

QUALIFIERS

All ideas, design arrangements, or plans indicated or represented by these drawings are owned by, and remain the sole property of The Douglas | Group. No ideas, designs, arrangements, or plans shall be disclosed to any other person, firm, or corporation for any purpose whatsoever without the express written consent of The Douglas | Group.

All Artwork and Drawings required under the scope of these documents are to become the sole property of the Owner at the completion of the contract, with all original, or created artwork or drawings to be surrendered to the Owner at the end of fulfillment of the contract or sooner if requested in writing from the Owner.

All artwork and Drawings are not to be reproduced or circulated for use outside the scope of this contract without written consent of the Owner. Failure to do so will result in legal action to the fullest extent of the law.



REVISIONS:

DESCRIPTION DATE

OWNER

Architect of the Capitol
Architecture Division Room H2-529
Ford House Office Bldg.
2nd. and D Streets S.W.
Washington, D.C. 20024
TEL: 202-226-1820 FAX: 202-226-1981

ENVIRONMENTAL GRAPHIC DESIGNER

The Douglas|Group 915 Duke Street Alexandria, VA 22202 TEL: 703-549-8050 FAX: 703-549-8053

DESIGN INTENT DRAWINGS FOR SUPERINTENDENT APPROVAL

APPROVAL:

LARRY STOFFELL SUPERINTENDENT SENATE OFFICE BUILDINGS

SIGNATURE

BUILDING NAME

HART SENATE OFFICE BUILDING
PROJECT TITLE

CAPITOL COMPLEX - WAYFINDING & ADA COMPLIANCE

DRAWING TITLE

PROJECT NOTES

SCALE DRAWN BY CHECKED BY

SH/MB

PROJ. NO. IFB NO.

24512.02

CAD FILE NO.

DRAWING NO.


SHEET DATE

Project Information

Abbreviations

@	At	Incl.	Included, Including
ADD.	Addendum	Int.	Interior
Adj.	Adjacent	Jt.	Joint
A.F.F.	Above Finish Floor	Max.	Maximum
Aggr.	Aggregate	M. D.	Medium Density
Alt.	Alternate	Min.	Minimum
Al. or Alum.	Aluminum	Mtl.	Metal
Anod.	Anodized	Misc.	Miscellaneous
Approx.	Approximate	Mtd.	Mounted
Arch.	Architect	N. I. C.	Not in Contract
Bd.	Board	No.	Number
Bet.	Between	N. T. S.	Not to Scale
Bldg.	Building	O. A.	Overall
Blk. or Blkg.	Block or Blocking	O. C.	On Center
Brz.	Bronze	O. D.	Outside Diameter
Cab.	Cabinet	Орр.	Opposite
CL	Centerline	Орр. Н.	Opposite Hand
Clr.	Clear	P. Lam.	Plastic Laminate
Conc.	Concrete	Perf.	Perforate (d)
C. M. U.	Concrete Masonry Unit	Plywd.	Plywood
Demo.	Demolish, Demolition	Pnl.	Panel
Det. or DT	Detail	Pr.	Pair
Dwgs.	Drawings	Pt.	Point
Ea.	Each	P. T.	Pressure Treated
Ele.	Elevation	Ptd.	Painted
Elev.	Elevator	Ref.	Reference
Encl.	Enclose (ure)	Sect.	Section
Equip.	Equipment	S. F.	Square Feet
Eq.	Equal	Sht.	Sheet
Exist.	Existing	Sim.	Similar
Ext	Exterior	Std.	Standard
Fin.	Finish (ed)	Stl.	Steel
GA	Gage	Susp.	Suspended
Galv.	Galvanized	Thk.	Thick
Gen.	General	Тур.	Typical
GWB	Gypsum Wall Board	U. O. N.	Unless Otherwise Noted
Gyp. Bd.	Gypsum Wall Board	Vert.	Vertical
Hdwd.	Hardwood	V. I. F.	Verify in Field
Hdwr.	Hardware	W/	With
Horiz.	Horizontal	W/O	Without
Ht.	Height	W. W. F.	Welded Wire Fabric
I. D.	Inside Diameter	Wd.	Wood


Section Details

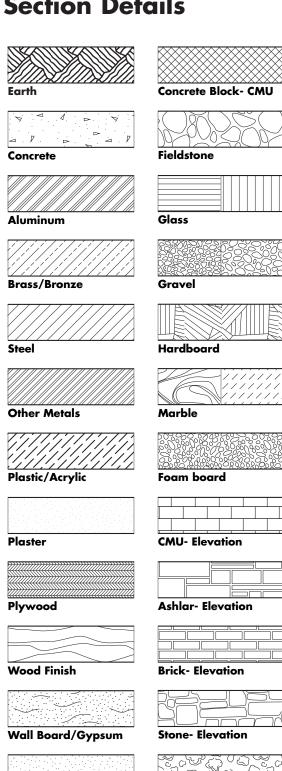

Trees- Plan


Sand

Project References

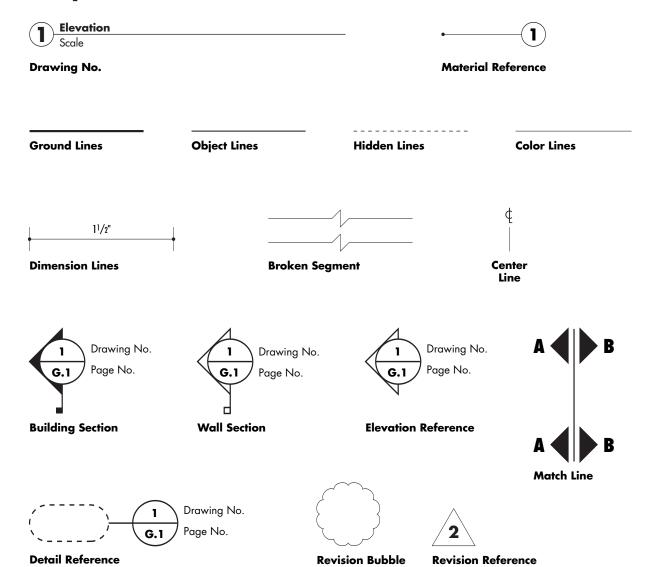

Message Schedule Reference

Detail Reference

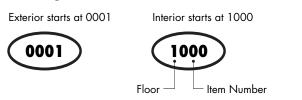



Revision Reference

ABCDEFGHIJKLMNOPQRSTUVWXYZ abcdefghijklmnopqrstuvwxyz ,:?/"'!@#\$%^&*() 1234567890

Adobe Garamond - Regular


ABCDEFGHIJKLMNOPQRSTUVWXYZ abcdefghijklmnopqrstuvwxyz ,:?/"'!@#\$%^&*() 1234567890

Adobe Garamond - Semi-Bold


ABCDEFGHIJKLMNOPQRSTUVWXYZ abcdefghijklmnopqrstuvwxyz .?/"'!@#\$%^&*() 1234567890

Adobe Garamond - Bold

Project Graphics

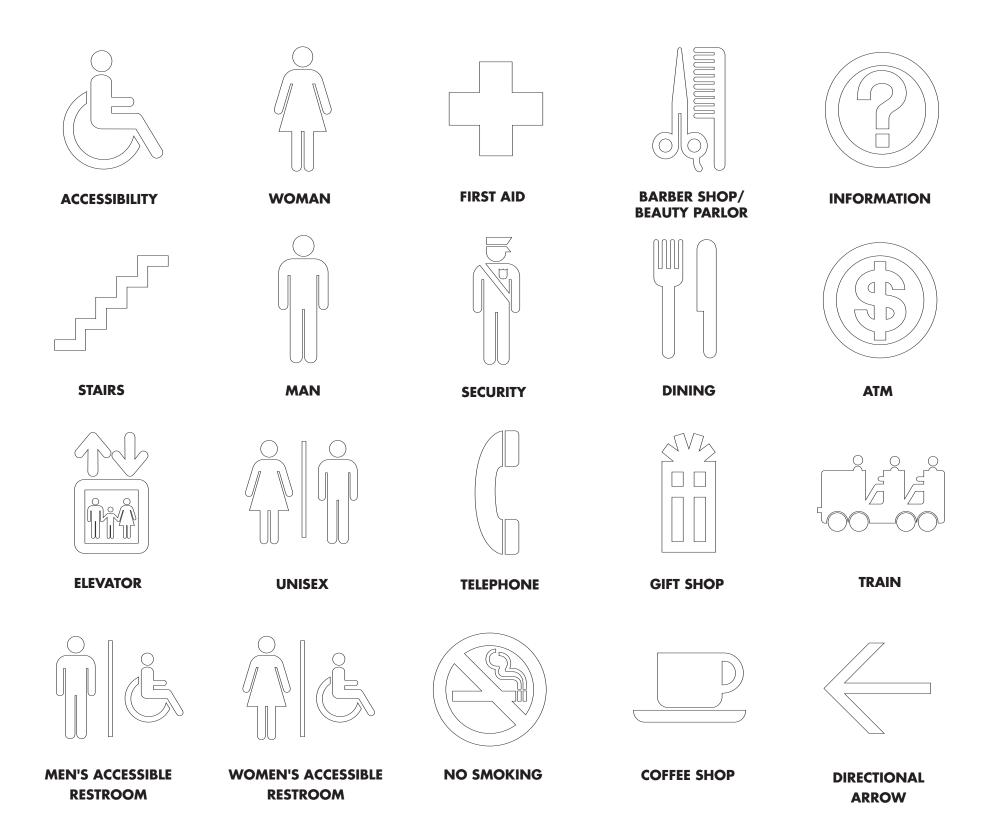

Project Signage

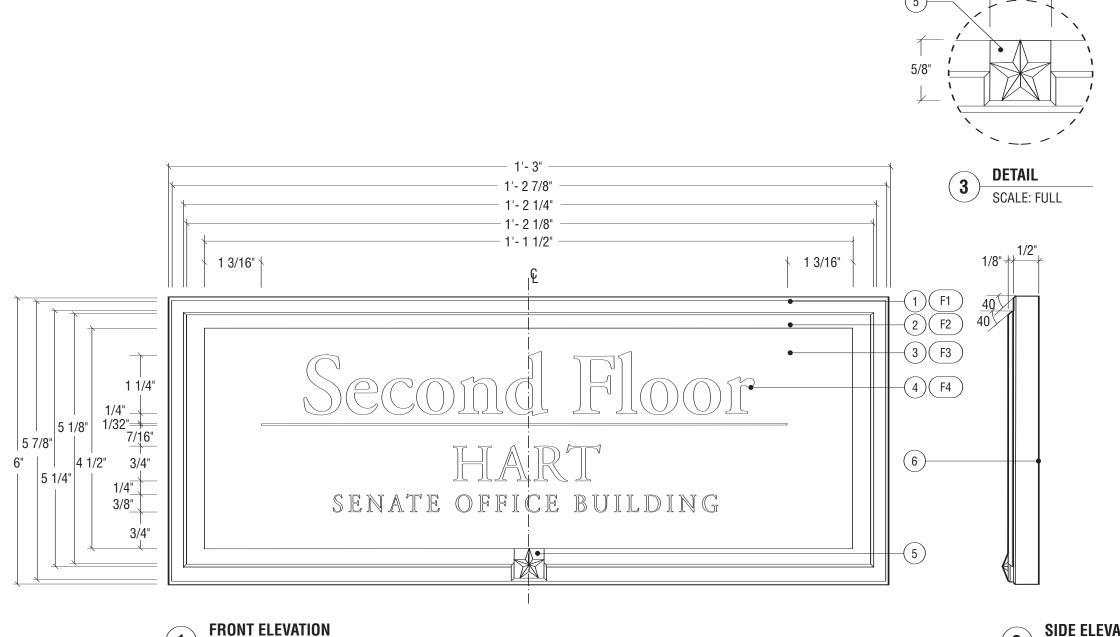

- Aluminum with mitered cornered and beveled edges.
- 2. Bronze bar stock with mitered cornered and beveled edges.
- 3. White sintra panel
- 4. Adobe Garamond Semi-Bold & Regular, as illustrated.
- 5. Cast bronze prismatic star, mechanically fastened to frame with concealed mechanical fasteners to prevent removal.
- 6. Sign mounts with double sided 3M VHB tape and silicone. Wall substraight varies (plaster, marble/granite, wood, etc.), solutions should be specialized or accommodate all while not unnecessarily &/or permanently damaging the wall surface.
- F1. Clear anodized, satin finish, horizontal grain (parallel to frame component) on all sides.
- F2. Clear powder coat finish, horizontal grain (parallel to frame component) on all sides.
- F3. Screen print to match Benjamin Moore Black Bean Soup 2130-10. Satin finish.
- F4. Symbols to be dropped out, exposing white sintra.



REVISIONS:
NO DESCRIPTION DATE

OWNER

Architect of the Capitol
Architecture Division Room H2-529
Ford House Office Bldg.
2nd. and D Streets S.W.
Washington, D.C. 20024
TEL: 202-226-1820 FAX: 202-226-1981

ENVIRONMENTAL GRAPHIC DESIGNER

The Douglas|Group 915 Duke Street Alexandria, VA 22202 TEL: 703-549-8050 FAX: 703-549-8053

DESIGN INTENT DRAWINGS FOR SUPERINTENDENT APPROVAL

APPROVAL:

LARRY STOFFELL SUPERINTENDENT SENATE OFFICE BUILDINGS

SIGNATURE BUILDING NAME

HART SENATE OFFICE BUILDING
PROJECT TITLE
CAPITOL COMPLEX - WAYFINDING

& ADA COMPLIANCE DRAWING TITLE

A - Level Identification


SCALE DRAWN BY CHECKED BY
SH/MB
PROJ. NO. IFB NO.
24512.02
CAD FILE NO.
DRAWING NO.

D.1.0


SHEET DATE 06/14/06

SIDE ELEVATION

SCALE: 1/2" = 1"

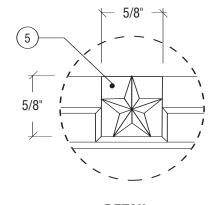



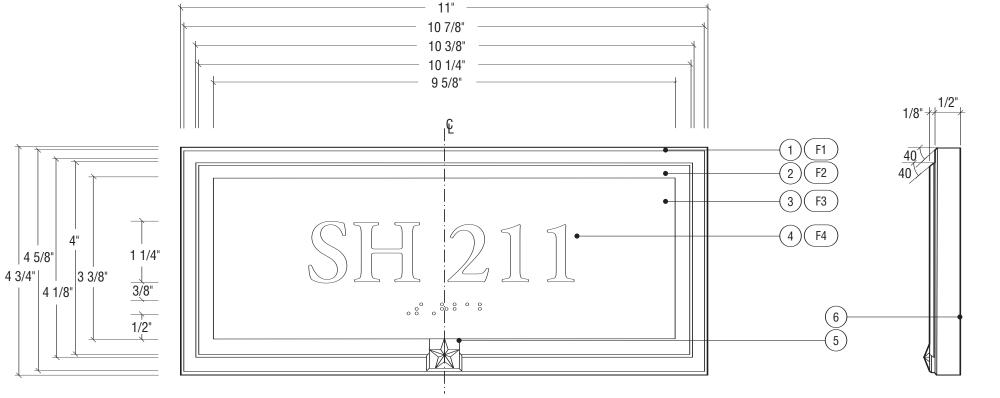

FRONT ELEVATION

SCALE: 1/2" = 1"



Notes

- 1. Aluminum with mitered cornered and beveled edges.
- 2. Bronze bar stock with mitered cornered and beveled edges.
- 3. Exterior grade photo-polymer plate with 1/32 raised text and Grade II Braille
- 4. Adobe Garamond Family, as illustrated. All symbols to match those on Project Symbols sheet.
- 5. Cast bronze prismatic star, mechanically fastened to frame with concealed mechanical fasteners to prevent removal.
- 6. Sign mounts with double sided 3M VHB tape and silicone. Mount to wall with center of the sign at 5'-0". Wall substraight varies (plaster, marble/granite, wood, etc.), solutions should be specialized or accommodate all while not unnecessarily &/or permanently damaging the wall surface.
- F1. Clear anodized, satin finish, horizontal grain (parallel to frame component) on all sides.
- F2. Clear powder coat finish, horizontal grain (parallel to frame component) on all sides.
- F3. Photo-polymer painted to match Benjamin Moore Black Bean Soup 2130-10. Eggshell finish.
- F4. Tactile letters tipped white.



REVISIONS:
NO DESCRIPTION DATE

OWNER

Architect of the Capitol
Architecture Division Room H2-529
Ford House Office Bldg.
2nd. and D Streets S.W.
Washington, D.C. 20024
TEL: 202-226-1820 FAX: 202-226-1981

ENVIRONMENTAL GRAPHIC DESIGNER

The Douglas|Group 915 Duke Street Alexandria, VA 22202 TEL: 703-549-8050 FAX: 703-549-8053

DESIGN INTENT DRAWINGS FOR SUPERINTENDENT APPROVAL

APPROVAL:

SHEET


LARRY STOFFELL SUPERINTENDENT SENATE OFFICE BUILDINGS

SIGNATURE
BUILDING NAME
HART SENATE OFFICE BUILDING
PROJECT TITLE
CAPITOL COMPLEX - WAYFINDING
& ADA COMPLIANCE
DRAWING TITLE
B.O - Room Number ID

SCALE DRAWN BY CHECKED BY
SH/MB
PROJ. NO. IFB NO.
24512.02
CAD FILE NO.

DATE 06/14/06

I © The Douglas Group. All rights reserved. No part of this document may be reproduced or utilized in any form without prior written authorization from The Douglas|Group. This document serves as a device to communicate design intent only. Fabrication and installation of the products represented herein will be derived from shop drawings produced by the contracted fabricator.

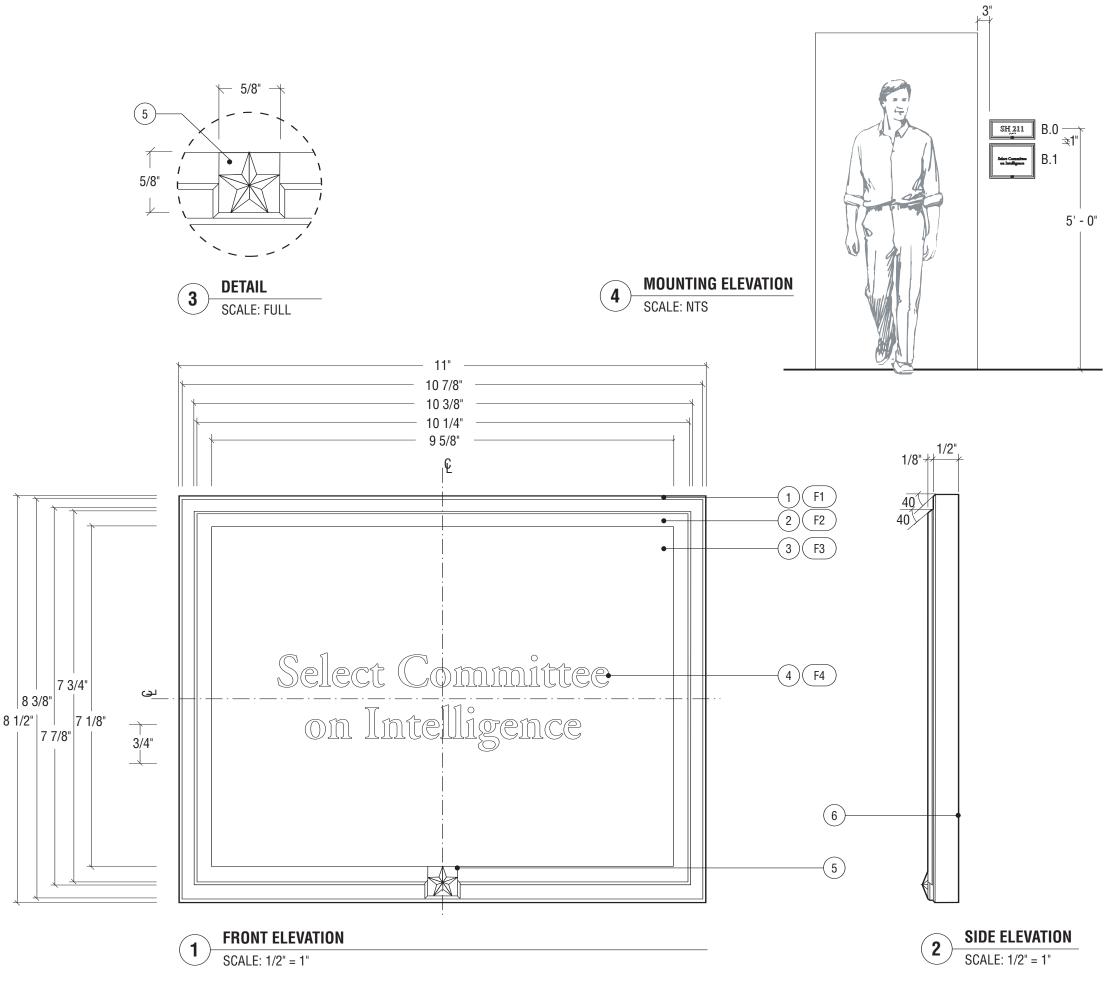

- Aluminum with mitered cornered and beveled edges.
- 2. Bronze bar stock with mitered cornered and beveled edges.
- 3. Exterior grade photo-polymer plate
- 4. Adobe Garamond Family, as illustrated. All symbols to match those on Project Symbols sheet.
- 5. Cast bronze prismatic star, mechanically fastened to frame with concealed mechanical fasteners to prevent removal.
- 6. Sign mounts with double sided 3M VHB tape and silicone. Sign is always mounted in alignmnet with and directly below type B.O unless noted otherwise. Wall substraight varies (plaster, marble/granite, wood, etc.), solutions should be specialized or accommodate all while not unnecessarily &/or permanently damaging the wall surface.
- F1. Clear anodized, satin finish, horizontal grain (parallel to frame component) on all sides.
- F2. Clear powder coat finish, horizontal grain (parallel to frame component) on all sides.
- F3. Photo-polymer painted to match Benjamin Moore Black Bean Soup 2130-10. Eggshell finish.
- F4. Screened letterforms, color white (not tactile).

NOTE:

FINAL MESSAGE MAY INCLUDE PRIMARY AND SECONDARY COPY OF VARYING CAP HEIGHTS. WHEN POSSIBLE, NO COPY SHOULD BE SMALLER THAN 5/8". FINAL LAYOUTS FOR THIS SIGN TYPE TO BE SUBMITTED FOR REVIEW PRIOR TO FABRICATION.



REVISIONS:
NO DESCRIPTION DATE

OWNER

Architect of the Capitol
Architecture Division Room H2-529
Ford House Office Bldg.
2nd. and D Streets S.W.
Washington, D.C. 20024
TEL: 202-226-1820 FAX: 202-226-1981

ENVIRONMENTAL GRAPHIC DESIGNER

The Douglas|Group 915 Duke Street Alexandria, VA 22202 TEL: 703-549-8050 FAX: 703-549-8053

DESIGN INTENT DRAWINGS FOR SUPERINTENDENT APPROVAL

APPROVAL:

LARRY STOFFELL SUPERINTENDENT SENATE OFFICE BUILDINGS


SIGNATURE

BUILDING NAME
HART SENATE OFFICE BUILDING
PROJECT TITLE
CAPITOL COMPLEX - WAYFINDING
& ADA COMPLIANCE
DRAWING TITLE
B.1 - Room Description
SCALE DRAWN BY CHECKED BY

SCALE DRAWN BY CHECKED BY
SH/MB
PROJ. NO. IFB NO.
24512.02
CAD FILE NO.
DRAWING NO.

D.3.0

DATE 06/14/06

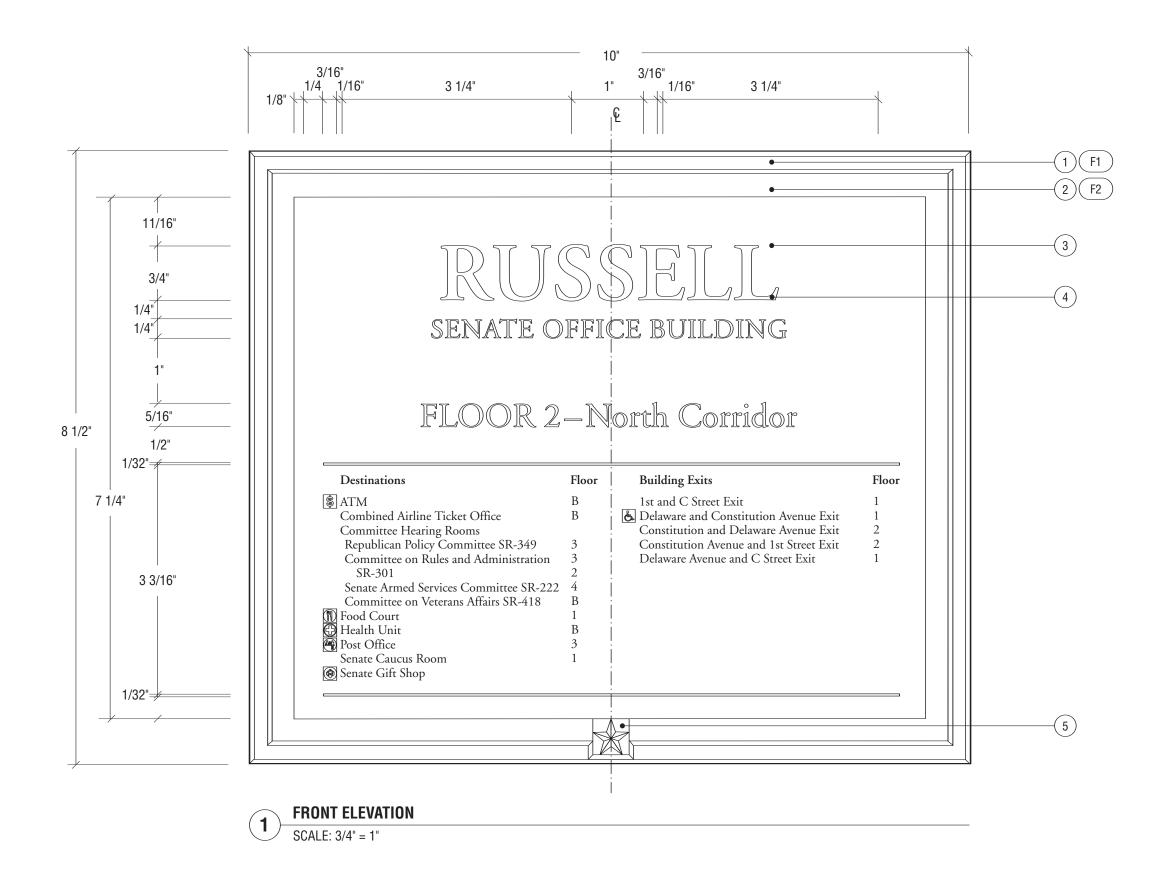

- 1. Aluminum with mitered cornered and beveled edges.
- 2. Bronze bar stock with mitered cornered and beveled edges.
- 3. Non-glare acrylic panel
- 4. Four color process plotted changeable graphic. Adobe Garamond family, as illustrated. All symbols to match those on Project Symbols sheet.
- 5. Cast bronze prismatic star, mechanically fastened to frame with concealed mechanical fasteners to prevent removal.
- 6. Note drawing Typical.1 for further dimensions and detail.
- 7. Note drawing ASSEMBLY.2 for "reference only" to fabrication method.
- F1. Clear anodized, satin finish, horizontal grain (parallel to frame component) on all sides.
- F2. Clear powder coat finish, horizontal grain (parallel to frame component) on all sides.

NOTE: LAYOUT ARTWORK FOR THIS SIGN TYPE TO BE PROVIDED BY GRAPHIC DESIGNER.



REVISIONS:

NO DESCRIPTION DATE

OWNER

Architect of the Capitol
Architecture Division Room H2-529
Ford House Office Bldg.
2nd. and D Streets S.W.
Washington, D.C. 20024
TEL: 202-226-1820 FAX: 202-226-1981

ENVIRONMENTAL GRAPHIC DESIGNER

The Douglas|Group 915 Duke Street Alexandria, VA 22202 TEL: 703-549-8050 FAX: 703-549-8053

DESIGN INTENT DRAWINGS FOR SUPERINTENDENT APPROVAL

APPROVAL:

BUILDING NAME

LARRY STOFFELL SUPERINTENDENT SENATE OFFICE BUILDINGS

SIGNATURE

HART SENATE OFFICE BUILDING
PROJECT TITLE
CAPITOL COMPLEX - WAYFINDING
& ADA COMPLIANCE
DRAWING TITLE
D - Destinations Directory

SCALE DRAWN BY CHECKED BY


SH/MB
PROJ. NO. IFB NO.

24512.02
CAD FILE NO.
DRAWING NO.

D. 4.0
SHEET DATE

06/14/06

|
© The Douglas Group. All rights reserved. No part of this document may be reproduced or utilized in any form without prior written authorization from The Douglas|Group. This document of the products represented herein will be derived from shop drawings produced by the contracted fabricator.

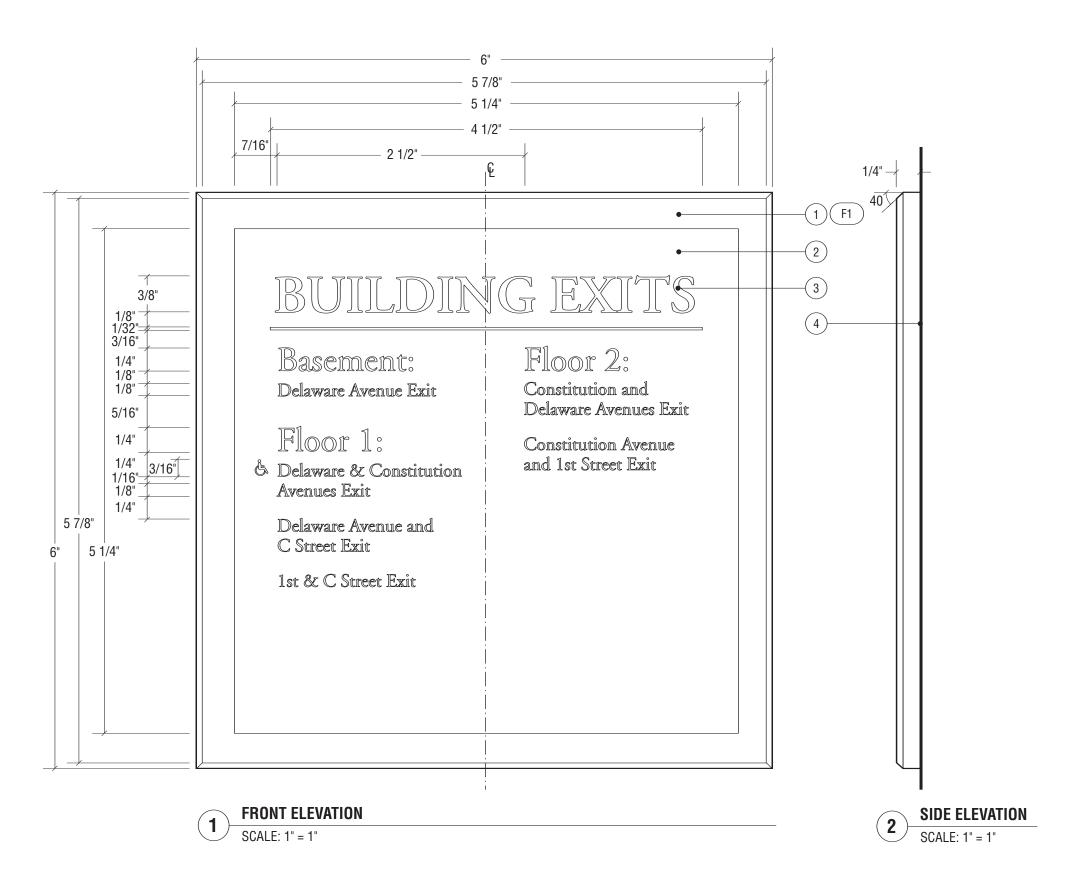

- 1. Bronze plate with beveled edges.
- 2. Non-glare acrylic panel
- 3. Four color process plotted changeable graphic. Adobe Garamond Family, as illustrated. All symbols to match those on Project Symbols sheet.
- 4. Sign mounts with double sided 3M VHB tape to interior panel of elevator. Wall substraight varies (plaster, marble/granite, wood, etc.), solutions should be specialized or accommodate all while not unnecessarily &/or permanently damaging the wall surface.
- 5. Note drawing ASSEMBLY.2 for "reference only" to fabrication method.
- F1. Clear powder coat finish, horizontal grain (parallel to frame component) on all sides.

NOTE: LAYOUT ARTWORK FOR THIS SIGN TYPE TO BE PROVIDED BY GRAPHIC DESIGNER.



REVISIONS: DESCRIPTION

OWNER

DATE

Architect of the Capitol Architecture Division Room H2-529 Ford House Office Bldg. 2nd. and D Streets S.W. Washington, D.C. 20024 TEL: 202-226-1820 FAX: 202-226-1981

ENVIRONMENTAL GRAPHIC DESIGNER

The Douglas|Group 915 Duke Street Alexandria, VA 22202 TEL: 703-549-8050 FAX: 703-549-8053

DESIGN INTENT DRAWINGS FOR SUPERINTENDENT APPROVAL

APPROVAL:

LARRY STOFFELL SUPERINTENDENT SENATE OFFICE BUILDINGS

SIGNATURE


HART SENATE OFFICE BUILDING PROJECT TITLE **CAPITOL COMPLEX - WAYFINDING** & ADA COMPLIANCE

DRAWING TITLE

BUILDING NAME

E - Exit Directory within Elevator

SCALE	DRAWN E	3Y	CHECKED BY
	SH/MB		
PROJ. NO) .	IFB NO.	
24512.02			
CAD FILE	NO.		
DRAWIN	G NO.		
	<u> </u>		
」し、	$\mathbf{O}_{\bullet}\mathbf{U}$		

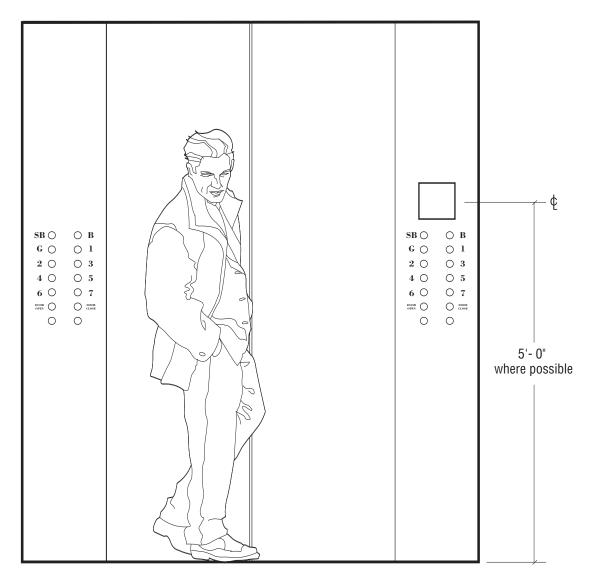

FRONT ELEVATION - ELEVATOR INTERIOR

SCALE: 3/4" = 1"- 0"



REVISIONS:
NO DESCRIPTION DATE

OWNER

Architect of the Capitol Architecture Division Room H2-529 Ford House Office Bldg. 2nd. and D Streets S.W. Washington, D.C. 20024

TEL: 202-226-1820 FAX: 202-226-1981

ENVIRONMENTAL GRAPHIC DESIGNER

The Douglas|Group 915 Duke Street Alexandria, VA 22202 TEL: 703-549-8050 FAX: 703-549-8053

DESIGN INTENT DRAWINGS FOR SUPERINTENDENT APPROVAL

APPROVAL:

LARRY STOFFELL SUPERINTENDENT SENATE OFFICE BUILDINGS

SIGNATURE

BUILDING NAME

HART SENATE OFFICE BUILDING PROJECT TITLE


CAPITOL COMPLEX - WAYFINDING & ADA COMPLIANCE

DRAWING TITLE

E - Exit Directory within Elevator

SCALE	DRAWN I	BY	CHECKED BY
	SH/MB		
PROJ. NO).	IFB NO.	
24512.02			
CAD FILE	NO.		
DRAWIN	G NO.		

D.5.1

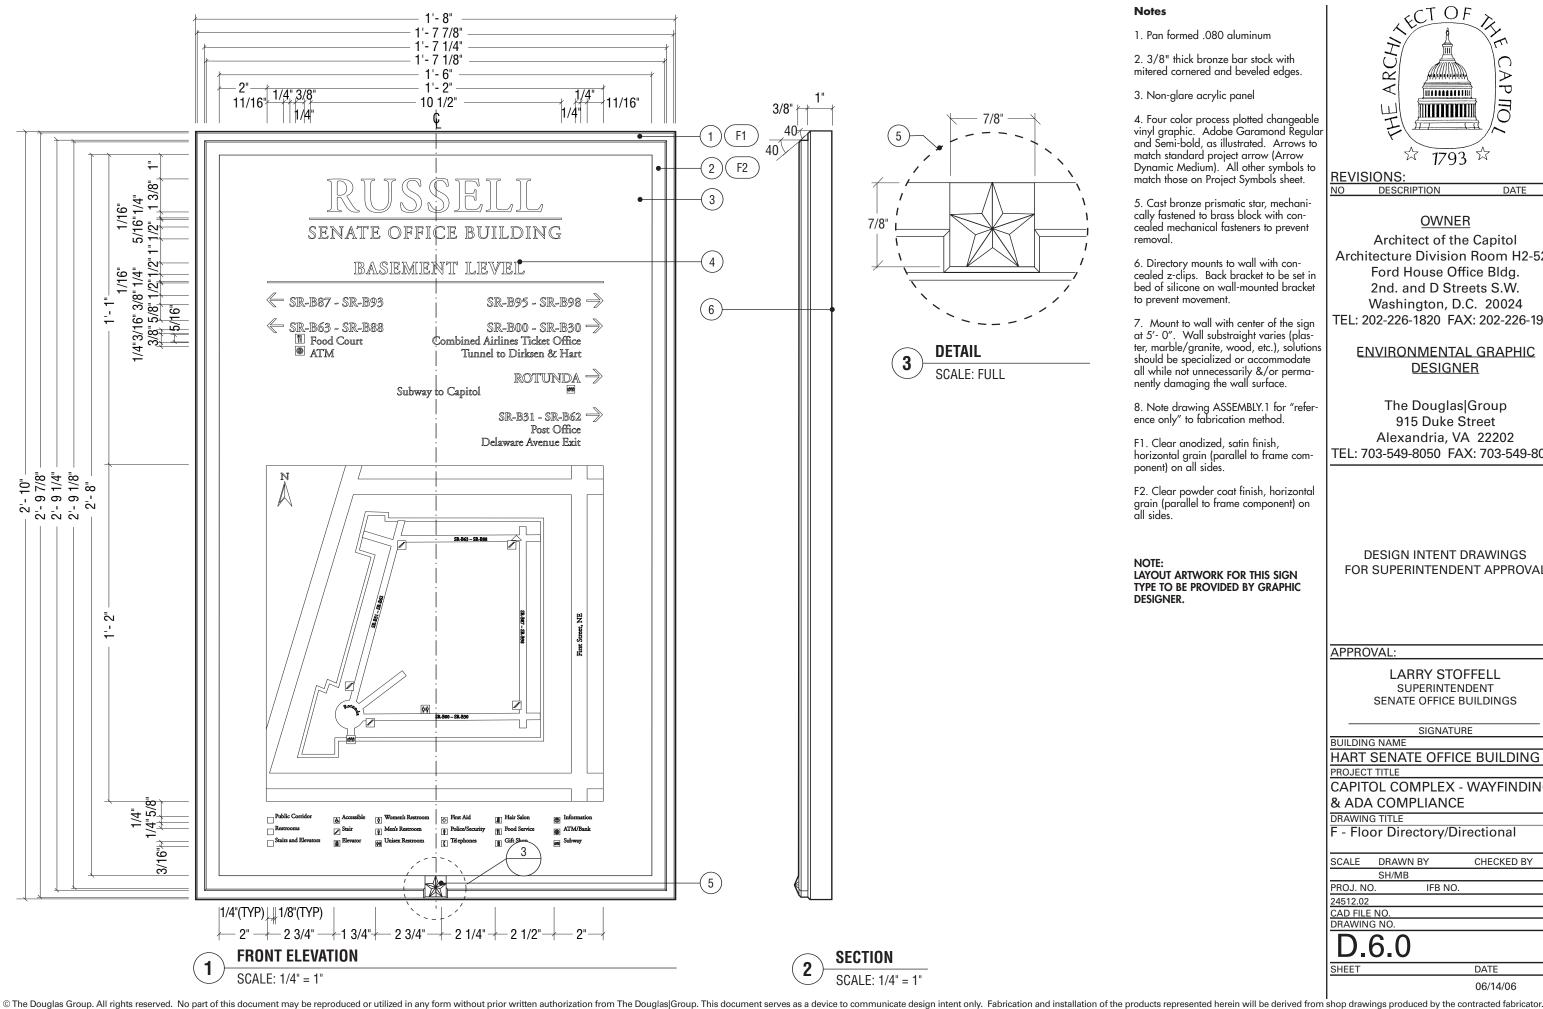

- 1. Pan formed .080 aluminum
- 2. 3/8" thick bronze bar stock with mitered cornered and beveled edges.
- 3. Non-glare acrylic panel
- 4. Four color process plotted changeable vinyl graphic. Adobe Garamond Regular and Semi-bold, as illustrated. Arrows to match standard project arrow (Arrow Dynamic Medium). All other symbols to match those on Project Symbols sheet.
- 5. Cast bronze prismatic star, mechanically fastened to brass block with concealed mechanical fasteners to prevent removal.
- 6. Directory mounts to wall with concealed z-clips. Back bracket to be set in bed of silicone on wall-mounted bracket to prevent movement.
- 7. Mount to wall with center of the sign at 5'-0". Wall substraight varies (plaster, marble/granite, wood, etc.), solutions should be specialized or accommodate all while not unnecessarily &/or permanently damaging the wall surface.
- 8. Note drawing ASSEMBLY.1 for "reference only" to fabrication method.
- F1. Clear anodized, satin finish, horizontal grain (parallel to frame component) on all sides.
- F2. Clear powder coat finish, horizontal grain (parallel to frame component) on all sides.

LAYOUT ARTWORK FOR THIS SIGN TYPE TO BE PROVIDED BY GRAPHIC DESIGNER.



REVISIONS: DESCRIPTION

OWNER

DATE

Architect of the Capitol Architecture Division Room H2-529 Ford House Office Bldg. 2nd. and D Streets S.W. Washington, D.C. 20024 TEL: 202-226-1820 FAX: 202-226-1981

ENVIRONMENTAL GRAPHIC DESIGNER

The Douglas|Group 915 Duke Street Alexandria, VA 22202 TEL: 703-549-8050 FAX: 703-549-8053

DESIGN INTENT DRAWINGS FOR SUPERINTENDENT APPROVAL

APPROVAL:


BUILDING NAME

LARRY STOFFELL SUPERINTENDENT SENATE OFFICE BUILDINGS

SIGNATURE

HART SENATE OFFICE BUILDING

PROJECT TITLE **CAPITOL COMPLEX - WAYFINDING** & ADA COMPLIANCE DRAWING TITLE F - Floor Directory/Directional SCALE DRAWN BY CHECKED BY SH/MB PROJ. NO. IFB NO. 24512.02 CAD FILE NO. DRAWING NO. D.6.0

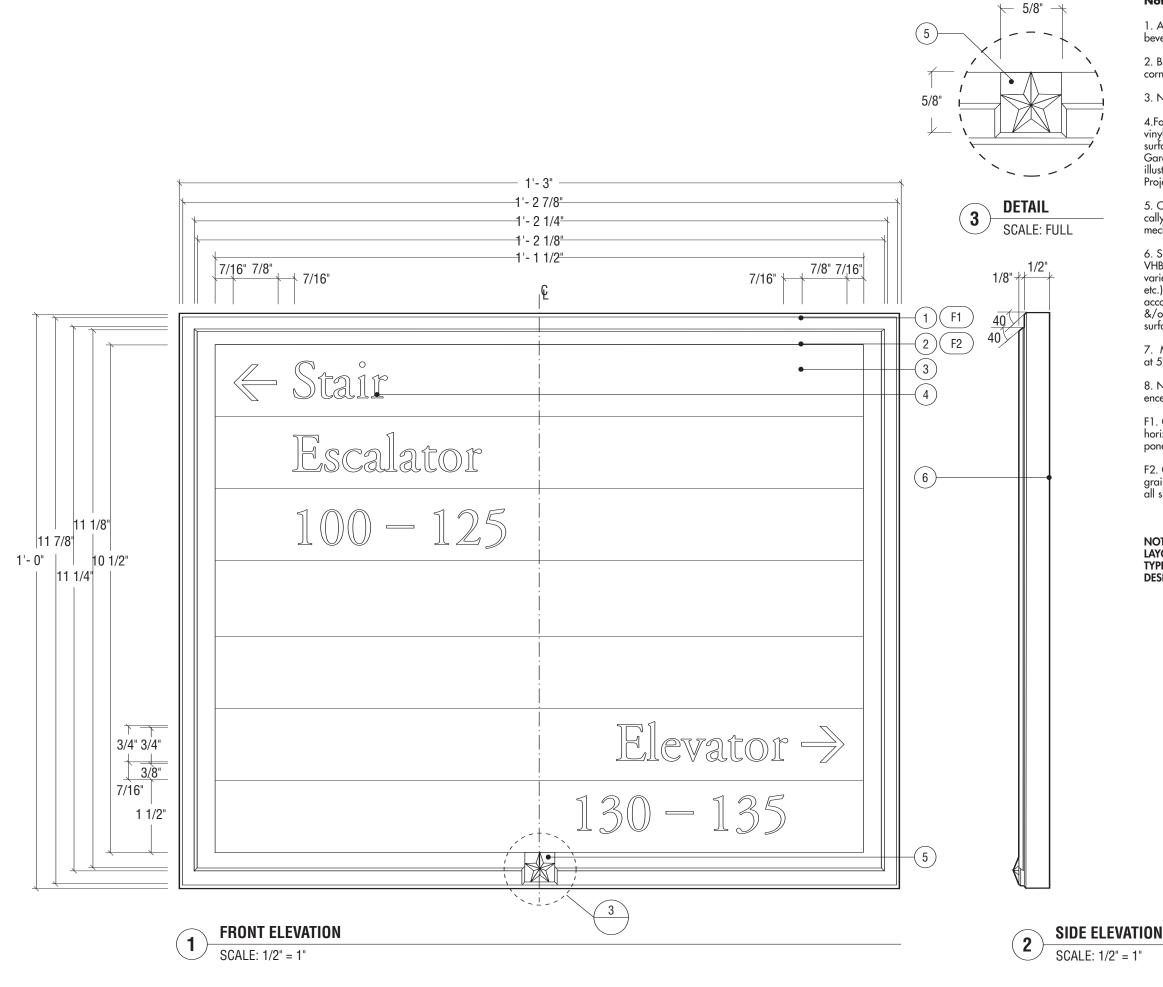

- 1. Aluminum with mitered cornered and beveled edges.
- 2. Bronze bar stock with mitered cornered and beveled edges.
- 3. Non-glare acrylic panel
- 4. Four color process plotted changeable vinyl graphic reverse applied to second surface of acrylic panel. Adobe Garamond Regular and Semi-bold, as illustrated. All symbols to match those on Project Symbols sheet.
- 5. Cast bronze prismatic star, mechanically fastened to frame with concealed mechanical fasteners to prevent removal
- 6. Sign mounts with double sided 3M VHB tape and silicone. Wall substraight varies (plaster, marble/granite, wood, etc.), solutions should be specialized or accommodate all while not unnecessarily &/or permanently damaging the wall surface
- 7. Mount to wall with center of the sign at 5'- 0".
- 8. Note drawing ASSEMBLY.2 for "reference only" to fabrication method.
- F1. Clear anodized, satin finish, horizontal grain (parallel to frame component) on all sides.
- F2. Clear powder coat finish, horizontal grain (parallel to frame component) on all sides.

NOTE: LAYOUT ARTWORK FOR THIS SIGN TYPE TO BE PROVIDED BY GRAPHIC DESIGNER.



REVISIONS:
NO DESCRIPTION DATE

OWNER

Architect of the Capitol
Architecture Division Room H2-529
Ford House Office Bldg.
2nd. and D Streets S.W.
Washington, D.C. 20024
TEL: 202-226-1820 FAX: 202-226-1981

ENVIRONMENTAL GRAPHIC DESIGNER

The Douglas|Group 915 Duke Street Alexandria, VA 22202 TEL: 703-549-8050 FAX: 703-549-8053

DESIGN INTENT DRAWINGS FOR SUPERINTENDENT APPROVAL

APPROVAL:

LARRY STOFFELL SUPERINTENDENT SENATE OFFICE BUILDINGS


SIGNATURE

BUILDING NAME
HART SENATE OFFICE BUILDING
PROJECT TITLE
CAPITOL COMPLEX - WAYFINDING
& ADA COMPLIANCE
DRAWING TITLE
G - Secondary Directional

SCALE DRAWN BY CHECKED BY
SH/MB
PROJ. NO. IFB NO.

D.7.0

24512.02 CAD FILE NO.

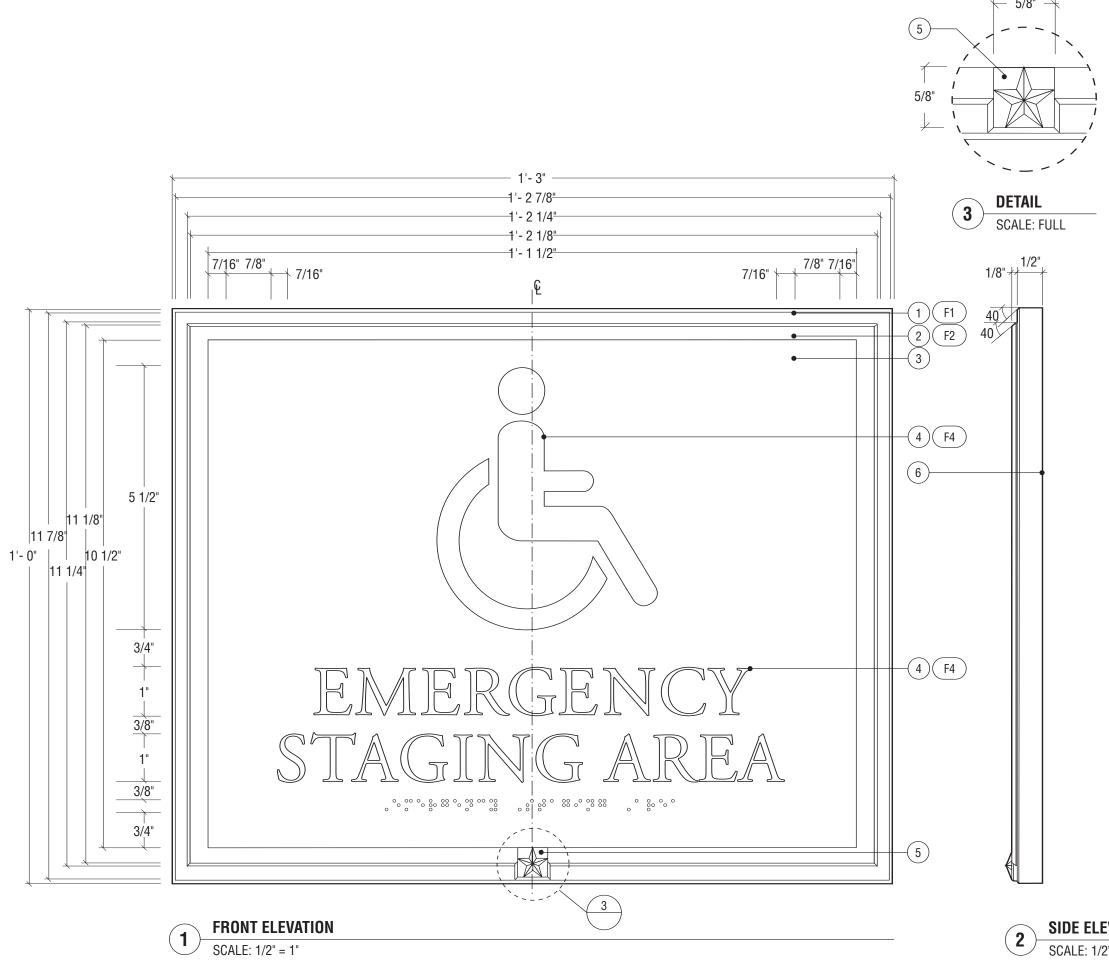

- 1. Aluminum with mitered cornered and beveled edges.
- 2. Bronze bar stock with mitered cornered and beveled edges.
- 3. Exterior grade photo-polymer plate with 1/32" raised text and Grade II
- 4. Adobe Garamond Family and ISA symbol as illustrated. All symbols to match those on Project Symbols sheet.
- 5. Cast bronze prismatic star, mechanically fastened to frame with concealed mechanical fasteners to prevent removal.
- 6. Sign mounts with double sided 3M VHB tape to interior panel of elevator. Mount to wall with center of the sign at 5'- 0". Wall substraight varies (plaster, marble/granite, wood, etc.), solutions should be specialized or accommodate all while not unnecessarily &/or permanently damaging the wall surface.
- F1. Clear anodized, satin finish, horizontal grain (parallel to frame component) on all sides.
- F2. Clear powder coat finish, horizontal grain (parallel to frame component) on all sides.
- F3. Photo-polymer painted blue to match Matthews MP07327. Eggshell finish.
- F4. Tactile letters and symbol tipped

NOTE:

THIS SIGN MAY BE USED IN SITUATIONS WHERE NO TACTILE AND BRAILLE INFORMATION IS REQUIRED. IF BRAILLE IS NOT INDICATED IN MESSAGE SCHED-**ULE, ANY APPLICABLE COPY TO BE SCREENED WHITE WITH NO TACTILE** FEATURES.

FINAL LAYOUTS FOR THIS SIGN TYPE TO BE SUBMITTED FOR REVIEW PRIOR TO FABRICATION.



REVISIONS: DESCRIPTION DATE

OWNER

Architect of the Capitol Architecture Division Room H2-529 Ford House Office Bldg. 2nd. and D Streets S.W. Washington, D.C. 20024 TEL: 202-226-1820 FAX: 202-226-1981

ENVIRONMENTAL GRAPHIC DESIGNER

The Douglas|Group 915 Duke Street Alexandria, VA 22202 TEL: 703-549-8050 FAX: 703-549-8053

DESIGN INTENT DRAWINGS FOR SUPERINTENDENT APPROVAL

APPROVAL:

LARRY STOFFELL SUPERINTENDENT SENATE OFFICE BUILDINGS

SIGNATURE

BUILDING NAME HART SENATE OFFICE BUILDING PROJECT TITLE **CAPITOL COMPLEX - WAYFINDING**

DRAWING TITLE


G.1 - Staging Identification

& ADA COMPLIANCE

SCALE	DRAWN E	3Y	CHECKED BY
	SH/MB		
PROJ. NO	Э.	IFB NO.	
24512.02			
CAD FILE	NO.		
DRAWIN	G NO.		
D	80		

SHEET DATE 06/14/06

© The Douglas Group. All rights reserved. No part of this document may be reproduced or utilized in any form without prior written authorization from The Douglas|Group. This document may be reproduced by the contracted fabricator.

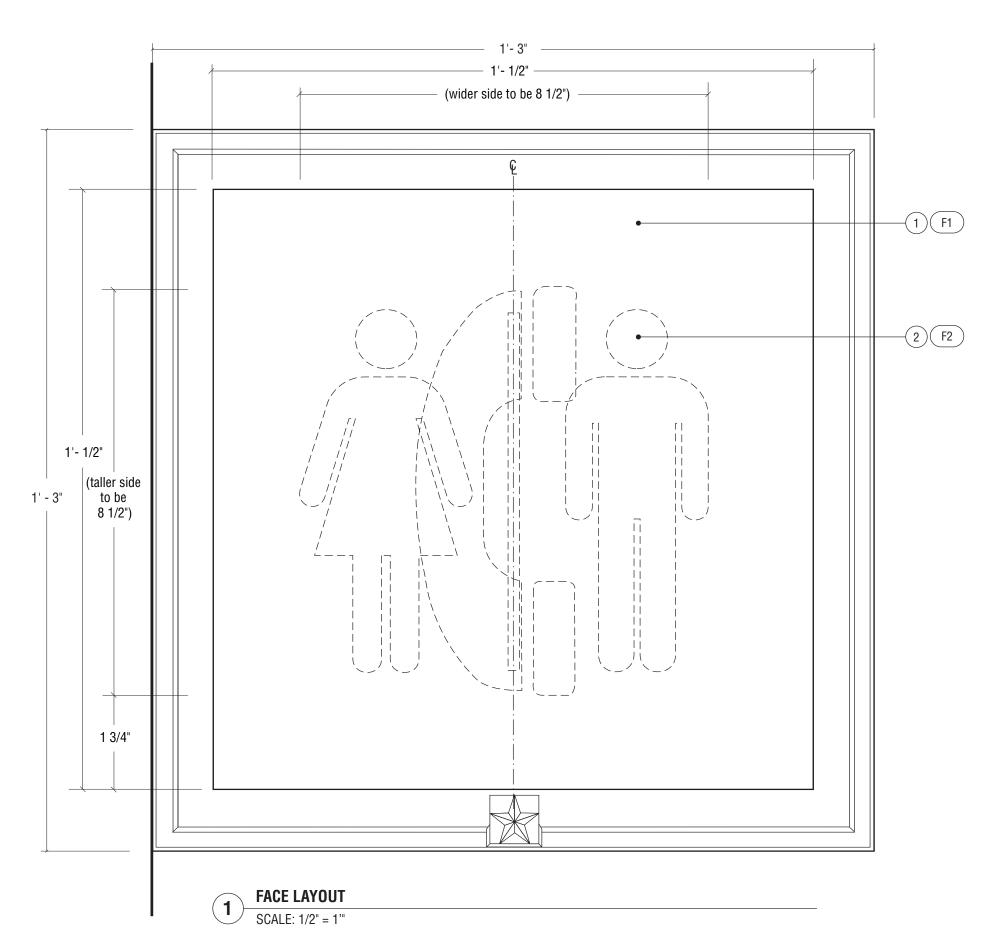

- 1. White sintra panel
- 2. All symbols to match those on Project Symbols sheet.
- 3. Note drawings TYPICAL 3 & TYPICAL
- 3.1 for further dimensions and detail.
- F1. Screen print to match Benjamin Moore Black Bean Soup 2130-10. Satin finish.
- F2. Symbols to be dropped out, exposing



REVISIONS:

DESCRIPTION DATE

OWNER

Architect of the Capitol Architecture Division Room H2-529 Ford House Office Bldg. 2nd. and D Streets S.W. Washington, D.C. 20024 TEL: 202-226-1820 FAX: 202-226-1981

ENVIRONMENTAL GRAPHIC DESIGNER

The Douglas|Group 915 Duke Street Alexandria, VA 22202 TEL: 703-549-8050 FAX: 703-549-8053

DESIGN INTENT DRAWINGS FOR SUPERINTENDENT APPROVAL

APPROVAL:

LARRY STOFFELL SUPERINTENDENT SENATE OFFICE BUILDINGS

SIGNATURE BUILDING NAME


HART SENATE OFFICE BUILDING PROJECT TITLE

CAPITOL COMPLEX - WAYFINDING & ADA COMPLIANCE

DRAWING TITLE

H - Identification Blade Graphic

SCALE DRAWN BY PROJ. NO. IFB NO. 24512.02 CAD FILE NO.

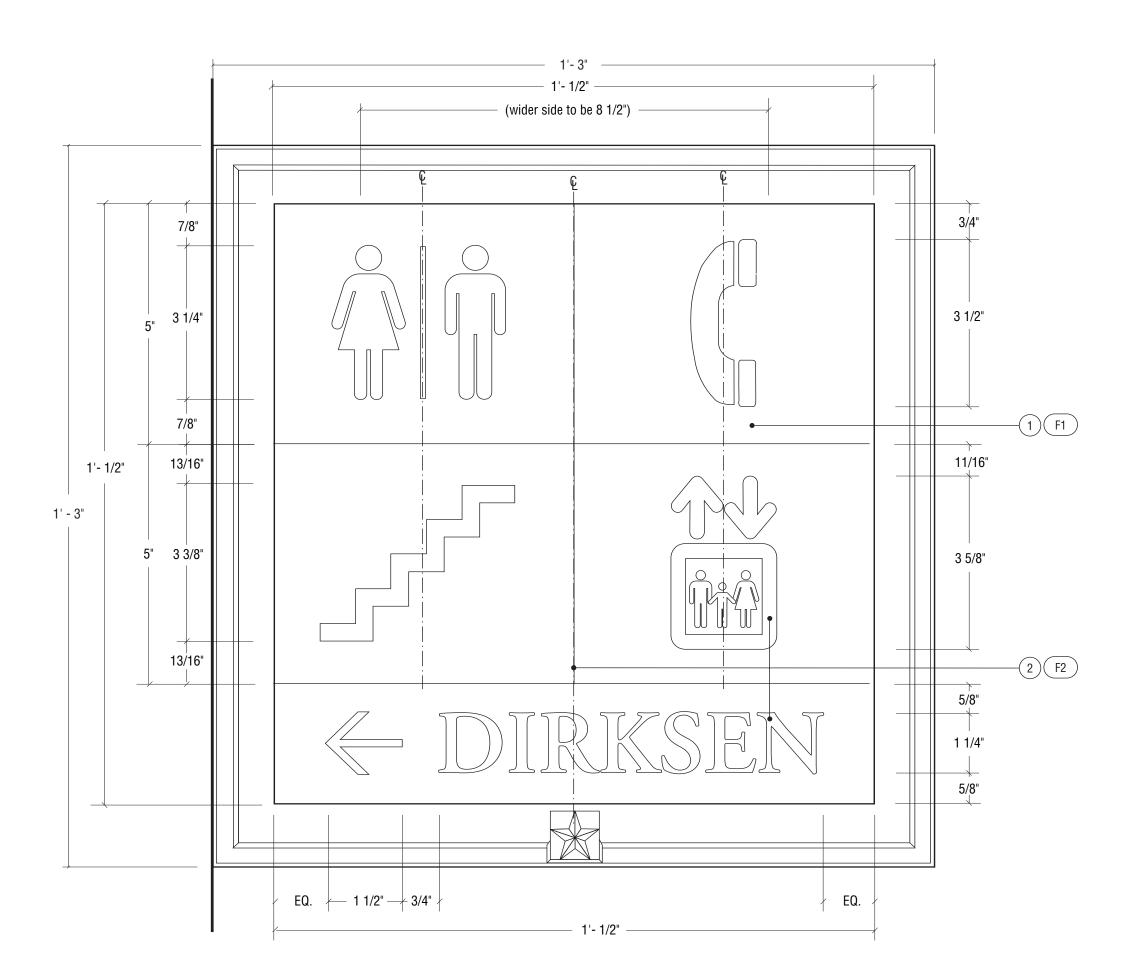

- 1. White sintra panel
- 2. Adobe Garamond Family, as illustrat ed. All symbols to match those on Project Symbols sheet.
- 3. Note drawings TYPICAL 3 & TYPICAL 3.1 for further dimensions and detail.
- F1. Screen print to match Benjamin Moore Black Bean Soup 2130-10. Satin finish.
- F2. Symbols to be dropped out, exposing white sintra.



REVISIONS:
NO DESCRIPTION DATE

OWNER

Architect of the Capitol Architecture Division Room H2-529 Ford House Office Bldg. 2nd. and D Streets S.W. Washington, D.C. 20024 TEL: 202-226-1820 FAX: 202-226-1981

ENVIRONMENTAL GRAPHIC DESIGNER

The Douglas|Group 915 Duke Street Alexandria, VA 22202 TEL: 703-549-8050 FAX: 703-549-8053

DESIGN INTENT DRAWINGS FOR SUPERINTENDENT APPROVAL

APPROVAL:

LARRY STOFFELL SUPERINTENDENT SENATE OFFICE BUILDINGS

SIGNATURE BUILDING NAME


HART SENATE OFFICE BUILDING PROJECT TITLE

CAPITOL COMPLEX - WAYFINDING & ADA COMPLIANCE

DRAWING TITLE

H.1 - Ident. & Direct. Blade Graphic

SCALE DRAWN BY CHECKED BY PROJ. NO. IFB NO. 24512.02 CAD FILE NO.

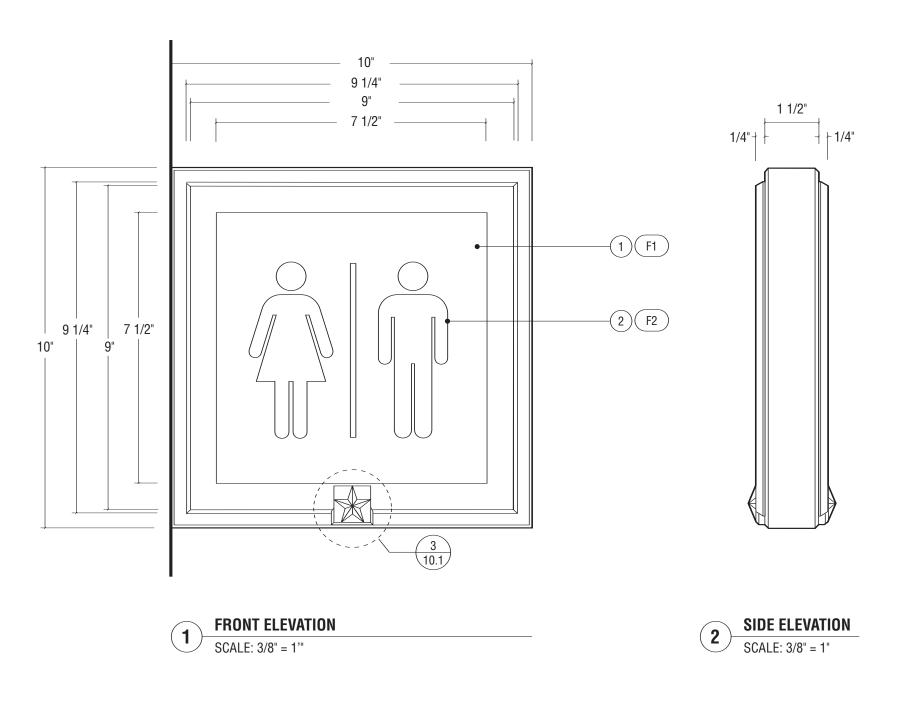

- 1. White sintra panell
- 2. All symbols to match those on Project Symbols sheet.
- 3. Note drawings TYPICAL 3 & TYPICAL 3.1 for similar construction details. (Dimensions as indicated on this page)
- F1. Screen print to match Benjamin Moore Black Bean Soup 2130-10. Satin finish.
- F2. Symbols to be dropped out, exposing NO white sintra.



REVISIONS:
NO DESCRIPTION DATE

OWNER

Architect of the Capitol Architecture Division Room H2-529 Ford House Office Bldg. 2nd. and D Streets S.W. Washington, D.C. 20024 TEL: 202-226-1820 FAX: 202-226-1981

ENVIRONMENTAL GRAPHIC DESIGNER

The Douglas|Group 915 Duke Street Alexandria, VA 22202 TEL: 703-549-8050 FAX: 703-549-8053

DESIGN INTENT DRAWINGS FOR SUPERINTENDENT APPROVAL

APPROVAL:

LARRY STOFFELL SUPERINTENDENT SENATE OFFICE BUILDINGS


SIGNATURE


BUILDING NAME HART SENATE OFFICE BUILDING PROJECT TITLE **CAPITOL COMPLEX - WAYFINDING** & ADA COMPLIANCE

DRAWING TITLE

H.2 - Blade Graphic - Small

SCALE	DRAWN BY	CHECKED BY
	SH/MB	
PROJ. NO). IF	B NO.
24512.02		
CAD FILE	NO.	
DRAWING	3 NO.	
D. 1	0.1	

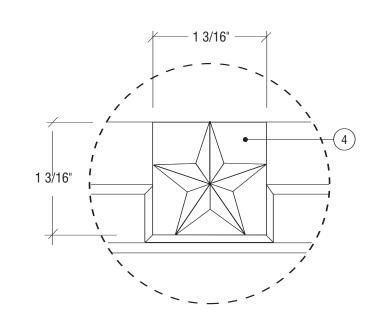

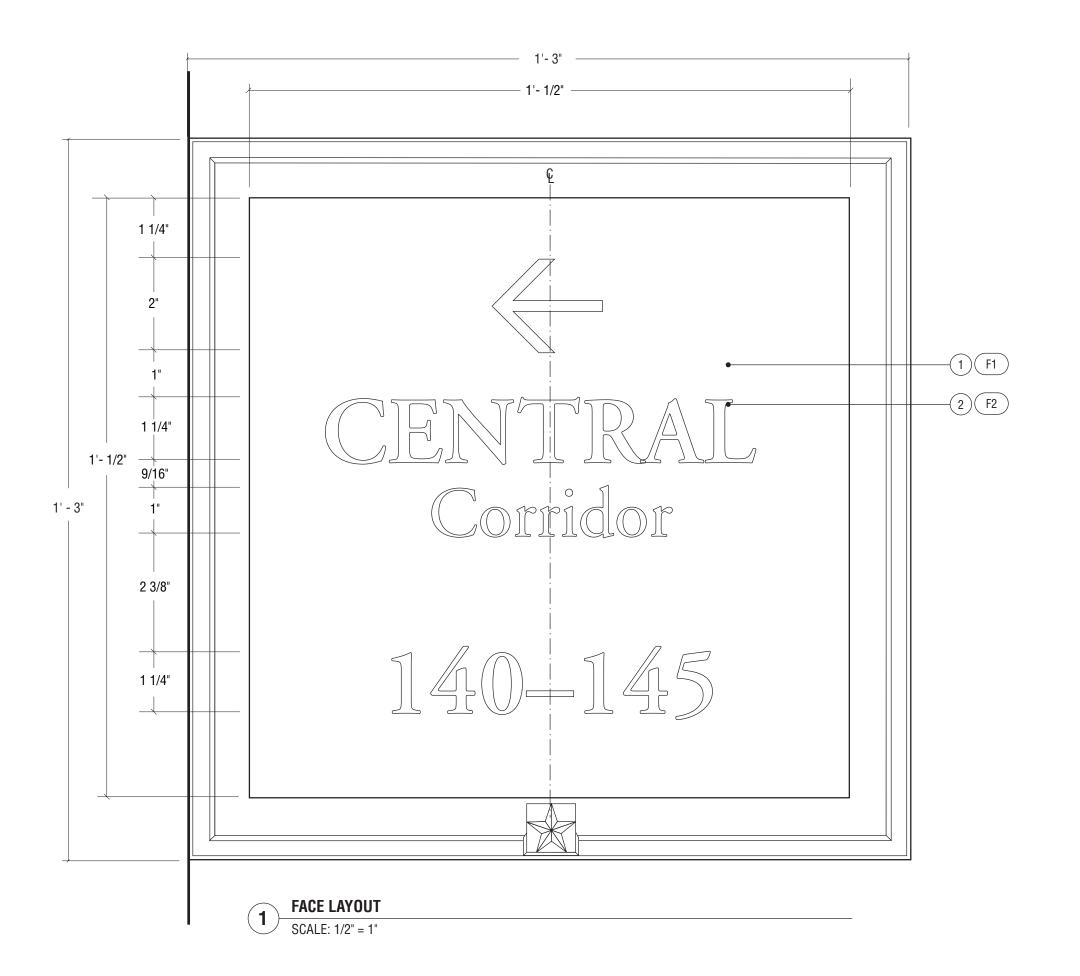

- 1. White sintra panel
- 2. Adobe Garamond Family, as illustrated. All symbols to match those on Project Symbols sheet.
- 3. Note drawings TYPICAL 3 & TYPICAL 3.1 for further dimensions and detail.
- F1. Screen print to match Benjamin Moore Black Bean Soup 2130-10. Satin finish.
- F2. Symbols to be dropped out, exposing white sintra.



REVISIONS:

DESCRIPTION DATE

OWNER

Architect of the Capitol
Architecture Division Room H2-529
Ford House Office Bldg.
2nd. and D Streets S.W.
Washington, D.C. 20024
TEL: 202-226-1820 FAX: 202-226-1981

ENVIRONMENTAL GRAPHIC DESIGNER

The Douglas|Group 915 Duke Street Alexandria, VA 22202 TEL: 703-549-8050 FAX: 703-549-8053

DESIGN INTENT DRAWINGS FOR SUPERINTENDENT APPROVAL

APPROVAL:

BUILDING NAME

LARRY STOFFELL SUPERINTENDENT SENATE OFFICE BUILDINGS


SIGNATURE

HART SENATE OFFICE BUILDING
PROJECT TITLE
CAPITOL COMPLEX - WAYFINDING
& ADA COMPLIANCE
DRAWING TITLE

I - Directional Blade Graphic

SCALE DRAWN BY CHECKED BY
SH/MB
PROJ. NO. IFB NO.
24512.02
CAD FILE NO.
DRAWING NO.

D.11.0

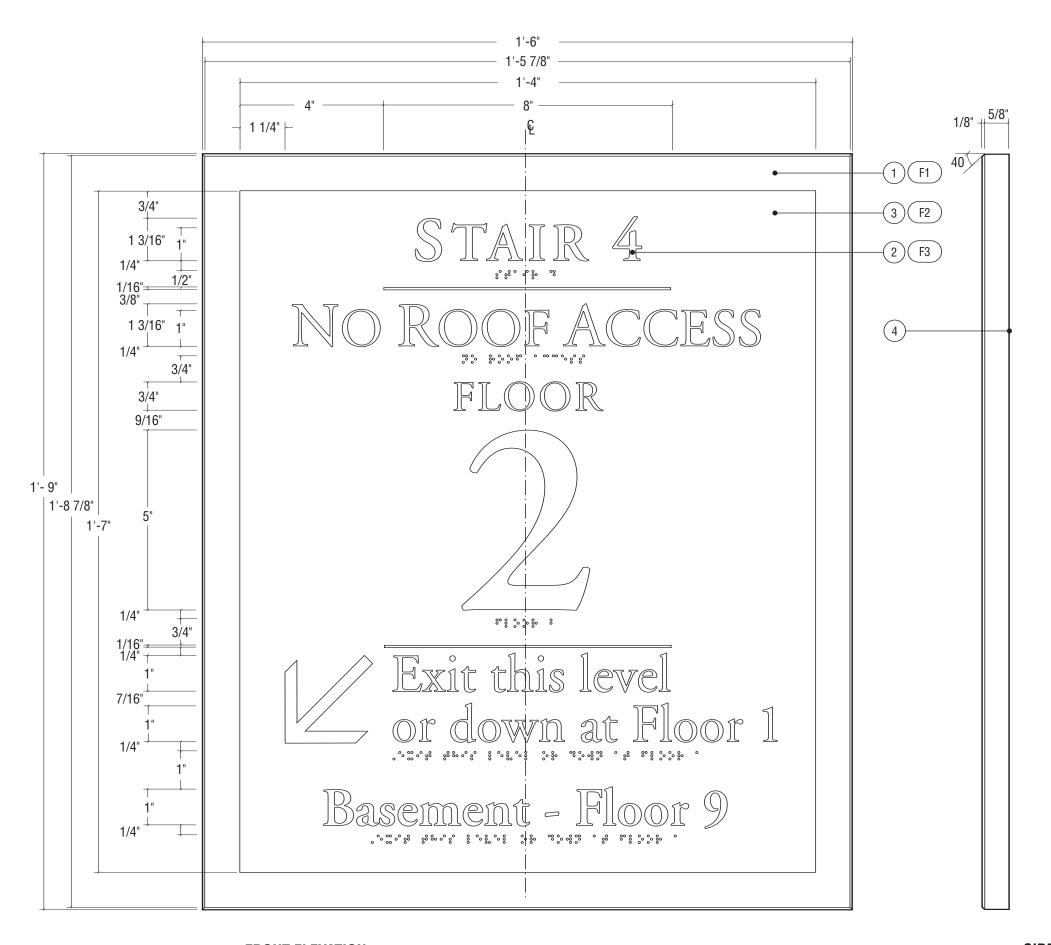

1 FRONT ELEVATION

SCALE: 3/8" = 1"

SIDE ELEVATION SCALE: 3/8" = 1"

Notes

- Bronze plate with beveled edges.
- Adobe Garamond Family, as illustrated. All symbols to match those on Project Symbols sheet.
- 3. Exterior grade photo-polymer plate with 1/32 raised text and Grade II Braille.
- 4. Sign mounts with double sided 3M VHB tape to interior panel of elevator. Mount to wall with center of the sign at 5'-0". Wall substraight varies (plaster, marble/granite, wood, etc.), solutions should be specialized or accommodate all while not unnecessarily &/or permanently damaging the wall surface.
- F1. Clear powder coat finish, horizontal grain (parallel to frame component) on all sides.
- F2. Prime and paint white. Mask raised letters and symbols. Paint background and braille with polyurethane acrylic paint satin finish to match Benjamin Moore Black Bean Soup 2130-10.
- F3. White



REVISIONS:

O DESCRIPTION DATE

OWNER

Architect of the Capitol
Architecture Division Room H2-529
Ford House Office Bldg.
2nd. and D Streets S.W.
Washington, D.C. 20024
TEL: 202-226-1820 FAX: 202-226-1981

ENVIRONMENTAL GRAPHIC DESIGNER

The Douglas|Group 915 Duke Street Alexandria, VA 22202 TEL: 703-549-8050 FAX: 703-549-8053

DESIGN INTENT DRAWINGS FOR SUPERINTENDENT APPROVAL

APPROVAL:

LARRY STOFFELL SUPERINTENDENT SENATE OFFICE BUILDINGS

SIGNATURE

BUILDING NAME

HART SENATE OFFICE BUILDING
PROJECT TITLE


CAPITOL COMPLEX - WAYFINDING & ADA COMPLIANCE

DRAWING TITLE

K - Stair Level Identification

SCALE DRAWN BY CHECKED BY
SH/MB
PROJ. NO. IFB NO.
24512.02
CAD FILE NO.
DRAWING NO.

D.12.0

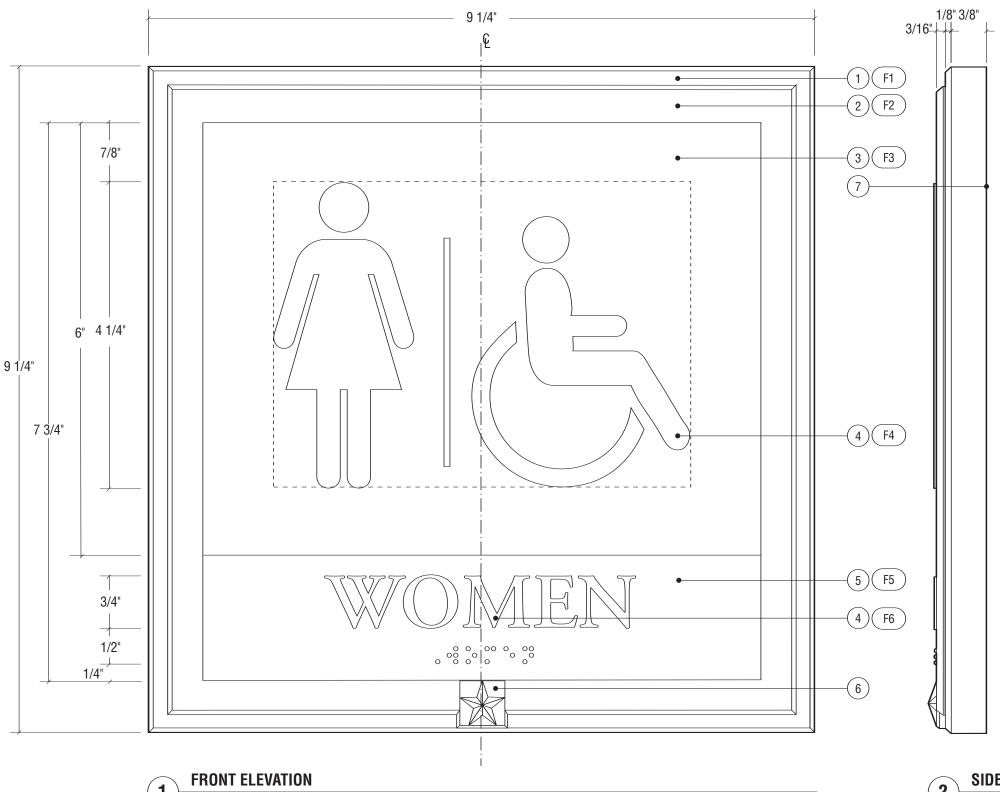

SCALE: 3/4" = 1"

Notes

- 1. Aluminum with mitered cornered and beveled edges.
- 2. Bronze bar stock with mitered cornered and beveled edges.
- 3. White sintra panel
- 4. Adobe Garamond Family, as illustrated. All symbols to match those on Project Symbols sheet.
- 5. Exterior grade photo-polymer plate with 1/32 raised text and Grade II Braille. Adobe Garamond Semi-bold, as illustrated.
- 6. Cast bronze prismatic star, mechanically fastened to frame with concealed mechanical fasteners to prevent removal.
- 7. Sign mounts with double sided 3M VHB tape and silicone. Wall substraight varies (plaster, marble/granite, wood, etc.), solutions should be specialized or accommodate all while not unnecessarily &/or permanently damaging the wall surface.
- 8. Note drawing TYPICAL 4 for further dimensions and detail.
- F1. Clear anodized, satin finish, horizontal grain (parallel to frame component) on all sides.
- F2. Clear powder coat finish, horizontal grain (parallel to frame component) on all sides.
- F3. Screen print to match Benjamin Moore Black Bean Soup 2130-10. Satin finish.
- F4. Symbols to be dropped out, exposing white sintra.
- F5. Prime and paint white. Mask raised letters and symbols. Paint background and braille with polyurethane acrylic paint satin finish to match Benjamin Moore Black Bean Soup 2130-10.
- F6. White



REVISIONS:

DESCRIPTION DATE

OWNER

Architect of the Capitol
Architecture Division Room H2-529
Ford House Office Bldg.
2nd. and D Streets S.W.
Washington, D.C. 20024
TEL: 202-226-1820 FAX: 202-226-1981

ENVIRONMENTAL GRAPHIC DESIGNER

The Douglas|Group 915 Duke Street Alexandria, VA 22202 TEL: 703-549-8050 FAX: 703-549-8053

DESIGN INTENT DRAWINGS FOR SUPERINTENDENT APPROVAL

APPROVAL:

SHEET

LARRY STOFFELL SUPERINTENDENT SENATE OFFICE BUILDINGS

SIGNATURE

BUILDING NAME

HART SENATE OFFICE BUILDING

PROJECT TITLE

CAPITOL COMPLEX - WAYFINDING
& ADA COMPLIANCE

DRAWING TITLE

L - Restroom Plaque


SCALE DRAWN BY CHECKED BY
SH/MB

PROJ. NO. IFB NO.
24512.02
CAD FILE NO.
DRAWING NO.

DATE 06/14/06

SIDE ELEVATION

SCALE: 3/4" = 1"

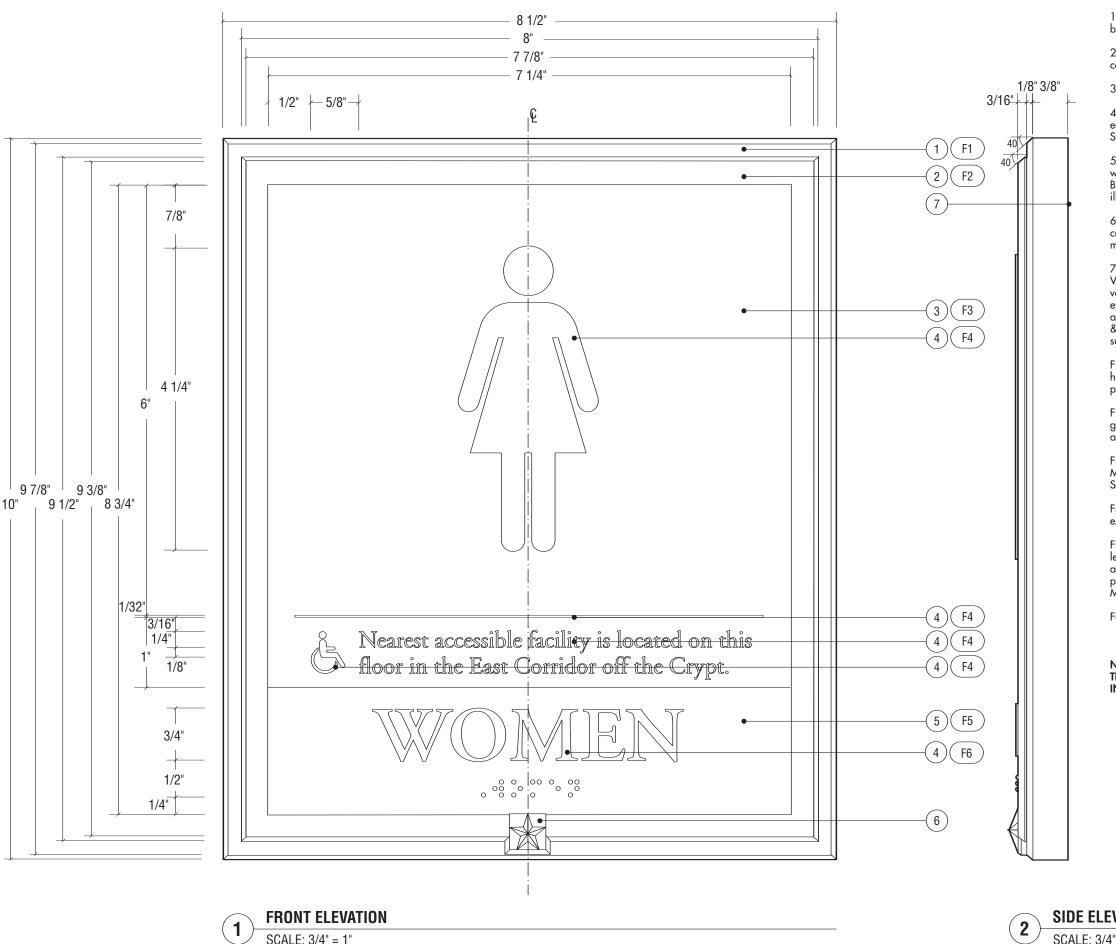

- 1. Aluminum with mitered cornered and beveled edges.
- 2. Bronze bar stock with mitered cornered and beveled edges.
- 3. White sintra panel
- 4. Adobe Garamond Regular, as illustrat ed. Symbols to match those on Project Symbols sheet.
- 5. Exterior grade photo-polymer plate with 1/32 raised text and Grade II Braille. Adobe Garamond Semi-bold, as illustrated.
- 6. Cast bronze prismatic star, mechanically fastened to frame with concealed mechanical fasteners to prevent removal.
- 7. Sign mounts with double sided 3M VHB tape and silicone. Wall substraight varies (plaster, marble/granite, wood, etc.), solutions should be specialized or accommodate all while not unnecessarily &/or permanently damaging the wall
- F1. Clear anodized, satin finish, horizontal grain (parallel to frame component) on all sides.
- F2. Clear powder coat finish, horizontal grain (parallel to frame component) on all sides.
- F3. Screen print to match Benjamin Moore Black Bean Soup 2130-10. Satin finish.
- F4. Symbols to be dropped out, exposing white sintra.
- F5. Prime and paint white. Mask raised letters and symbols. Paint background and braille with polyurethane acrylic paint satin finish to match Benjamin Moore Black Bean Soup 2130-10.
- F6. White

THIS SIGN TYPE NOT USED IN THE HART BUILDING



REVISIONS:

DESCRIPTION DATE

OWNER

Architect of the Capitol Architecture Division Room H2-529 Ford House Office Bldg. 2nd. and D Streets S.W. Washington, D.C. 20024 TEL: 202-226-1820 FAX: 202-226-1981

ENVIRONMENTAL GRAPHIC DESIGNER

The Douglas|Group 915 Duke Street Alexandria, VA 22202 TEL: 703-549-8050 FAX: 703-549-8053

DESIGN INTENT DRAWINGS FOR SUPERINTENDENT APPROVAL

APPROVAL:

BUILDING NAME

PROJECT TITLE

LARRY STOFFELL SUPERINTENDENT SENATE OFFICE BUILDINGS

SIGNATURE


HART SENATE OFFICE BUILDING

CAPITOL COMPLEX - WAYFINDING

& ADA COMPLIANCE DRAWING TITLE M - Accessible Restroom Directional SCALE DRAWN BY CHECKED BY SH/MB PROJ. NO. IFB NO. 24512.02 CAD FILE NO. SHEET DATE

06/14/06

SIDE ELEVATION

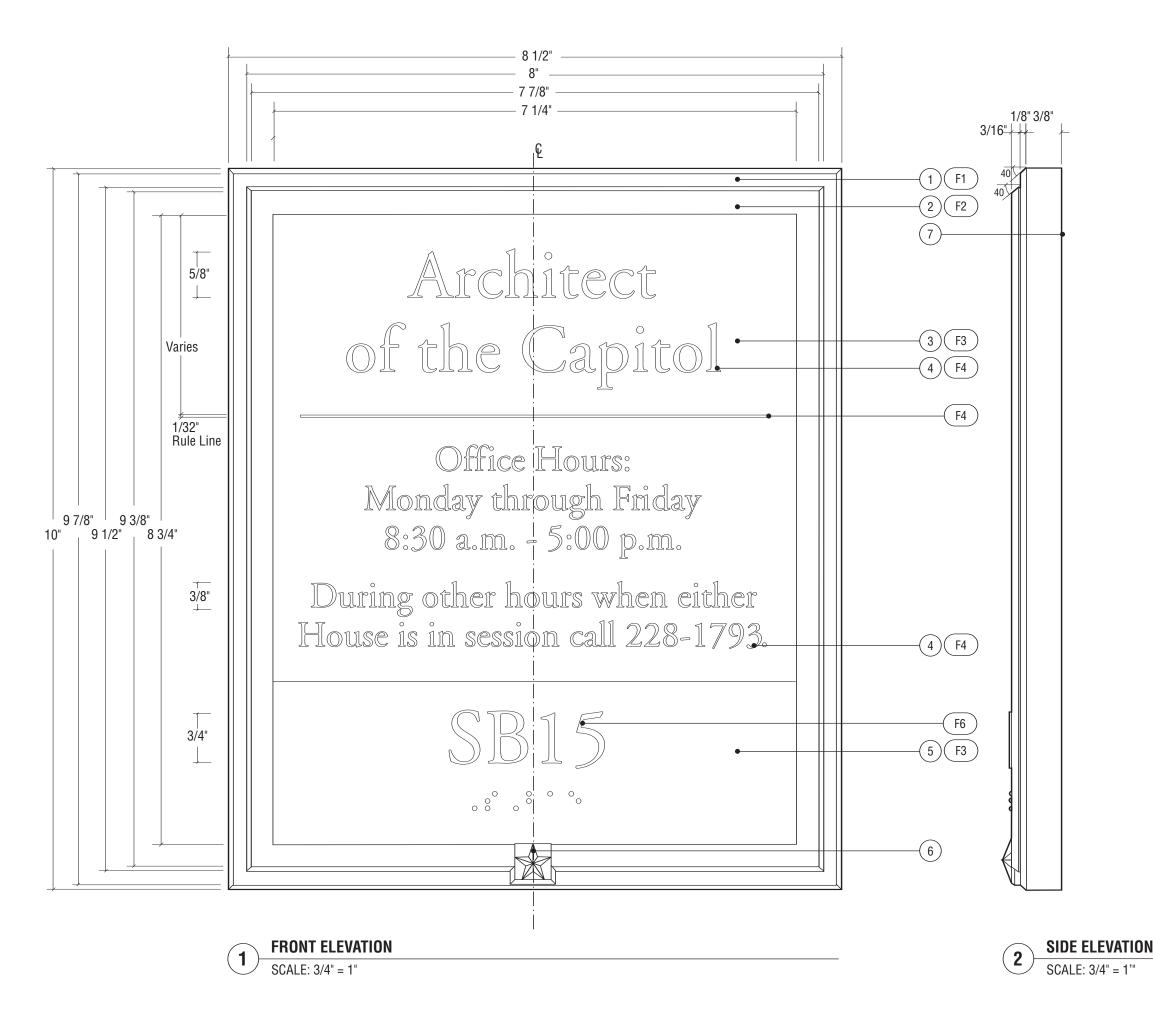

- Aluminum with mitered cornered and beveled edges.
- 2. Bronze bar stock with mitered cornered and beveled edges.
- 3. White sintra panel
- 4. Adobe Garamond Regular, as illustrated.
- 5. Exterior grade photo-polymer plate with 1/32 raised text and Grade II Braille. Adobe Garamond Regular, as illustrated.
- 6. Cast bronze prismatic star, mechanically fastened to frame with concealed mechanical fasteners to prevent removal.
- 7. Sign mounts with double sided 3M VHB tape and silicone. Wall substraight varies (plaster, marble/granite, wood, etc.), solutions should be specialized or accommodate all while not unnecessarily &/or permanently damaging the wall surface.
- F1. Clear anodized, satin finish, horizontal grain (parallel to frame component) on all sides.
- F2. Clear powder coat finish, horizontal grain (parallel to frame component) on all sides.
- F3. Paint to match Benjamin Moore Black Bean Soup 2130-10. Eggshell finish.
- F4. Screened white
- F6. Tipped White

NOTE: LAYOUT MAY VARY PER APPLICATION OF THIS SIGN TYPE. FINAL LAYOUTS TO BE SUBMITTED FOR REVIEW PRIOR TO FABRICATION.



REVISIONS:
NO DESCRIPTION DATE

OWNER

Architect of the Capitol
Architecture Division Room H2-529
Ford House Office Bldg.
2nd. and D Streets S.W.
Washington, D.C. 20024
TEL: 202-226-1820 FAX: 202-226-1981

ENVIRONMENTAL GRAPHIC DESIGNER

The Douglas|Group 915 Duke Street Alexandria, VA 22202 TEL: 703-549-8050 FAX: 703-549-8053

DESIGN INTENT DRAWINGS FOR SUPERINTENDENT APPROVAL

APPROVAL:

BUILDING NAME

LARRY STOFFELL SUPERINTENDENT SENATE OFFICE BUILDINGS


SIGNATURE

HOUSE OFFICE BUILDINGS
PROJECT TITLE
CAPITOL COMPLEX - WAYFINDING
& ADA COMPLIANCE
DRAWING TITLE
M.1 - Room ID - Small

SCALE DRAWN BY CHECKED BY
SH/MB
PROJ. NO. IFB NO.
24512.02
CAD FILE NO.
DRAWING NO.

D.14.1
SHEET DATE

© The Douglas Group. All rights reserved. No part of this document may be reproduced or utilized in any form without prior written authorization from The Douglas|Group. This document serves as a device to communicate design intent only. Fabrication and installation of the products represented herein will be derived from shop drawings produced by the contracted fabricator.

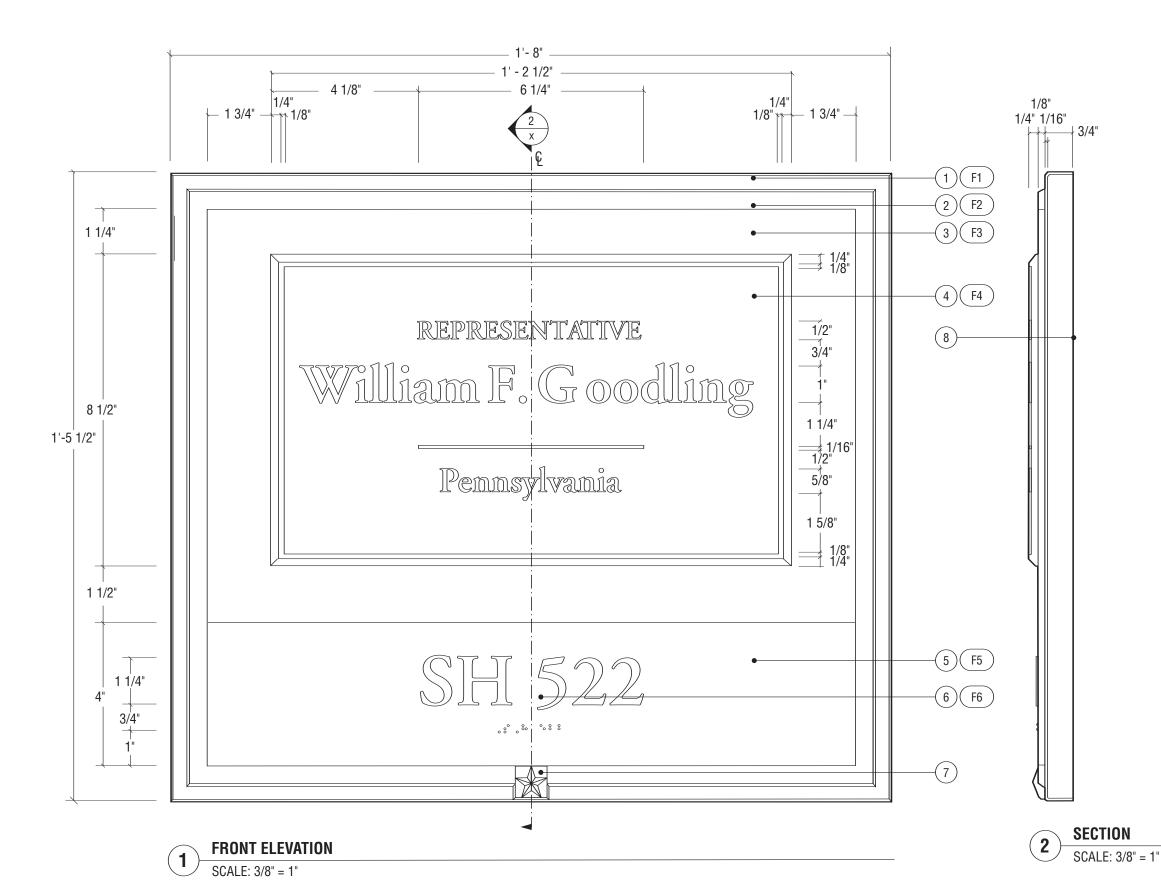

- 1. Aluminum with mitered cornered and beveled edges.
- 2. Bronze bar stock with mitered cornered and beveled edges.
- 3. Metal panel
- 4. Cast bronze plaque with 1/16" text and rule-line depth. Adobe Garamond Regular and Semibold, as illustrated. Single line border style. Plaque to attach to back metal panel (#3) with concealed fasteners. Plaque needs to be removable/changed-out by AOC staff when offices change (potentially yearly).

Note: K&R Industries will be the supplier for this component. Contact Patrick Hanrahan at (703) 631-4200

- 5. Etched metal plate with 1/32 raised text and Grade II Braille. Adobe Garamond Semi-bold, as illustrated.
- 6. Adobe Garamond Family as illustrat-
- 7. Cast bronze prismatic star, mechanically fastened to frame with concealed mechanical fasteners to prevent removal.
- 8. Directory mounts to wall with concealed z-clips. Back bracket to be set in bed of silicone on wall-mounted bracket to prevent movement.
- 9. Note drawing TYPICAL 2 for further dimensions and detail.
- F1. Clear anodized, satin finish, horizontal grain (parallel to frame component) on all sides.
- F2. Clear powder coat finish, horizontal grain (parallel to frame component) on
- F3. Prime and paint with polyurethane acrylic paint semi-gloss finish. Paint to match Benjamin Moore Black Bean Soup 2130-10.
- F4. Text and borders surface to have a horizontal grain (parallel to frame component) on all sides. Leatherette back-ground texture. Gloss diamond shield clear coat. Dark oxide background finish
- F5. Prime and paint white. Mask raised letters and symbols. Paint background and braille with polyurethane acrylic paint satin finish to match Benjamin Moore Black Bean Soup 2130-10.

F6. White



REVISIONS:

DESCRIPTION DATE

OWNER

Architect of the Capitol Architecture Division Room H2-529 Ford House Office Bldg. 2nd. and D Streets S.W. Washington, D.C. 20024 TEL: 202-226-1820 FAX: 202-226-1981

ENVIRONMENTAL GRAPHIC DESIGNER

The Douglas|Group 915 Duke Street Alexandria, VA 22202 TEL: 703-549-8050 FAX: 703-549-8053

DESIGN INTENT DRAWINGS FOR SUPERINTENDENT APPROVAL

APPROVAL:

LARRY STOFFELL SUPERINTENDENT SENATE OFFICE BUILDINGS

SIGNATURE


BUILDING NAME HART SENATE OFFICE BUILDING PROJECT TITLE CAPITOL COMPLEX - WAYFINDING & ADA COMPLIANCE

DRAWING TITLE

0.1 - Member Suite Identification

SCALE DRAWN BY CHECKED BY SH/MB PROJ. NO. IFB NO. 24512.02 CAD FILE NO.

D.15.0 SHEET DATE 06/14/06 © The Douglas Group. All rights reserved. No part of this document may be reproduced or utilized in any form without prior written authorization from The Douglas|Group. This document may be reproduced by the contracted fabricator.

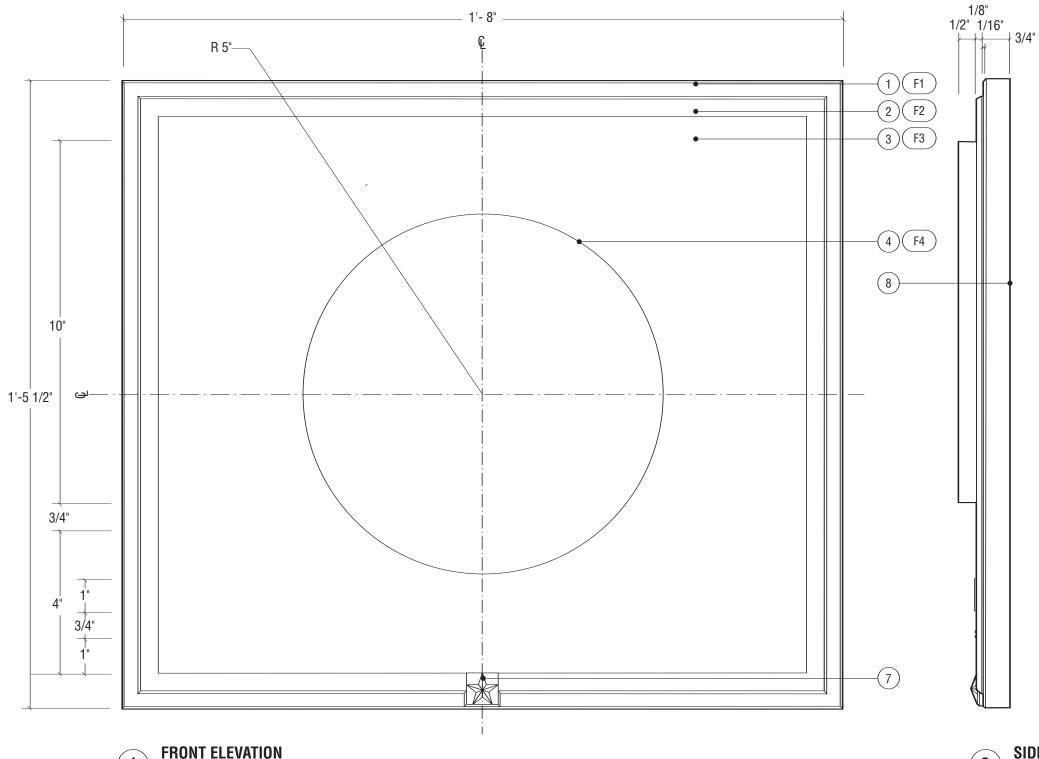

- 1. Aluminum with mitered cornered and beveled edges.
- 2. Bronze bar stock with mitered cornered and beveled edges.
- Metal panel
- 4. Cast bronze seal with 1/16" graphics in depth. Single line border style. Seal to attach to back metal panel (#3) with concealed fasteners. Seal needs to be removable/changed-out by AOC staff when offices change (potentially yearly).

NOTE: K&R Industries will be the supplier for this component. Contact Patrick Hanrahan at (703) 631-4200

5. N/A

6. N/A

- 7. Cast bronze prismatic star, mechanically fastened to frame with concealed mechanical fasteners to prevent removal.
- 8. Sign mounts to wall with concealed z-clips. Back bracket to be set in bed of silicone on wall-mounted bracket to prevent movement. Wall substraight varies (plaster, marble/granite, wood, etc.), solutions should be specialized or accommodate all while not unnecessarily &/or permanently damaging the wall surface.
- 9. Note drawing TYPICAL 2 for further dimensions and detail.
- F1. Clear anodized, satin finish, horizontal grain (parallel to frame component) on all sides.
- F2. Clear powder coat finish, horizontal grain (parallel to frame component) on all sides.
- F3. Prime and paint with polyurethane acrylic paint satin finish. Paint to match Benjamin Moore Black Bean Soup 2130-10.
- F4. Text and borders surface to have a horizontal grain (parallel to frame component) on all sides. Leatherette background texture. Gloss diamond shield clear coat. Dark oxide background finish stain.



REVISIONS:
NO DESCRIPTION DATE

OWNER

Architect of the Capitol
Architecture Division Room H2-529
Ford House Office Bldg.
2nd. and D Streets S.W.
Washington, D.C. 20024
TEL: 202-226-1820 FAX: 202-226-1981

ENVIRONMENTAL GRAPHIC DESIGNER

The Douglas|Group 915 Duke Street Alexandria, VA 22202 TEL: 703-549-8050 FAX: 703-549-8053

DESIGN INTENT DRAWINGS FOR SUPERINTENDENT APPROVAL

APPROVAL:

BUILDING NAME

LARRY STOFFELL SUPERINTENDENT SENATE OFFICE BUILDINGS

SIGNATURE

HART SENATE OFFICE BUILDING
PROJECT TITLE
CAPITOL COMPLEX - WAYFINDING
& ADA COMPLIANCE
DRAWING TITLE
O.2 - Member Suite Identification

SCALE DRAWN BY CHECKED BY
SH/MB
PROJ. NO. IFB NO.
24512.02
CAD FILE NO.
DRAWING NO.

D.16.0

SHEET DATE 06/14/06

SIDE ELEVATION

SCALE: 3/8" = 1



- 1. Aluminum with mitered cornered and beveled edges.
- 2. Bronze bar stock with mitered cornered and beveled edges.
- 3. White sintra panel
- 4. Adobe Garamond Semi-bold, as illustrated.
- 5. Etched metal plate with 1/32 raised text and Grade II Braille. Adobe Garamond Semi-bold, as illustrated.
- 6. Adobe Garamond Family as illustrated.
- 7. Cast bronze prismatic star, mechanically fastened to frame with concealed mechanical fasteners to prevent removal.
- 8. Directory mounts to wall with concealed z-clips. Back bracket to be set in bed of silicone on wall-mounted bracket to prevent movement. Wall substraight varies (plaster, marble/granite, wood, etc.), solutions should be specialized or accommodate all while not unnecessarily &/or permanently damaging the wall surface.
- 9. Note drawing TYPICAL 2 for further dimensions and detail.
- F1. Clear anodized, satin finish, horizontal grain (parallel to frame component) on all sides.
- F2. Clear powder coat finish, horizontal grain (parallel to frame component) on all sides.
- F3. Screen print to match Project Paint Color A.
- F4. Adobe Garamond Family to be dropped out, exposing white sintra.
- F5. Prime and paint white. Mask raised letters and symbols. Paint background and braille with polyurethane acrylic paint satin finish to match Benjamin Moore Black Bean Soup 2130-10.
- F6. White

SIDE ELEVATION

SCALE: 3/8" = 1"



REVISIONS:
NO DESCRIPTION DATE

OWNER

Architect of the Capitol
Architecture Division Room H2-529
Ford House Office Bldg.
2nd. and D Streets S.W.
Washington, D.C. 20024
TEL: 202-226-1820 FAX: 202-226-1981

ENVIRONMENTAL GRAPHIC DESIGNER

The Douglas|Group 915 Duke Street Alexandria, VA 22202 TEL: 703-549-8050 FAX: 703-549-8053

DESIGN INTENT DRAWINGS FOR SUPERINTENDENT APPROVAL

APPROVAL:

BUILDING NAME

LARRY STOFFELL SUPERINTENDENT SENATE OFFICE BUILDINGS

SIGNATURE


HART SENATE OFFICE BUILDING
PROJECT TITLE
CAPITOL COMPLEX - WAYFINDING
& ADA COMPLIANCE
DRAWING TITLE
S - Amenity Identification

SCALE DRAWN BY CHECKED BY
SH/MB
PROJ. NO. IFB NO.
24512.02
CAD FILE NO.
DRAWING NO.

D. 17.0
SHEET DATE

06/14/06

I © The Douglas Group. All rights reserved. No part of this document may be reproduced or utilized in any form without prior written authorization from The Douglas|Group. This document serves as a device to communicate design intent only. Fabrication and installation of the products represented herein will be derived from shop drawings produced by the contracted fabricator.

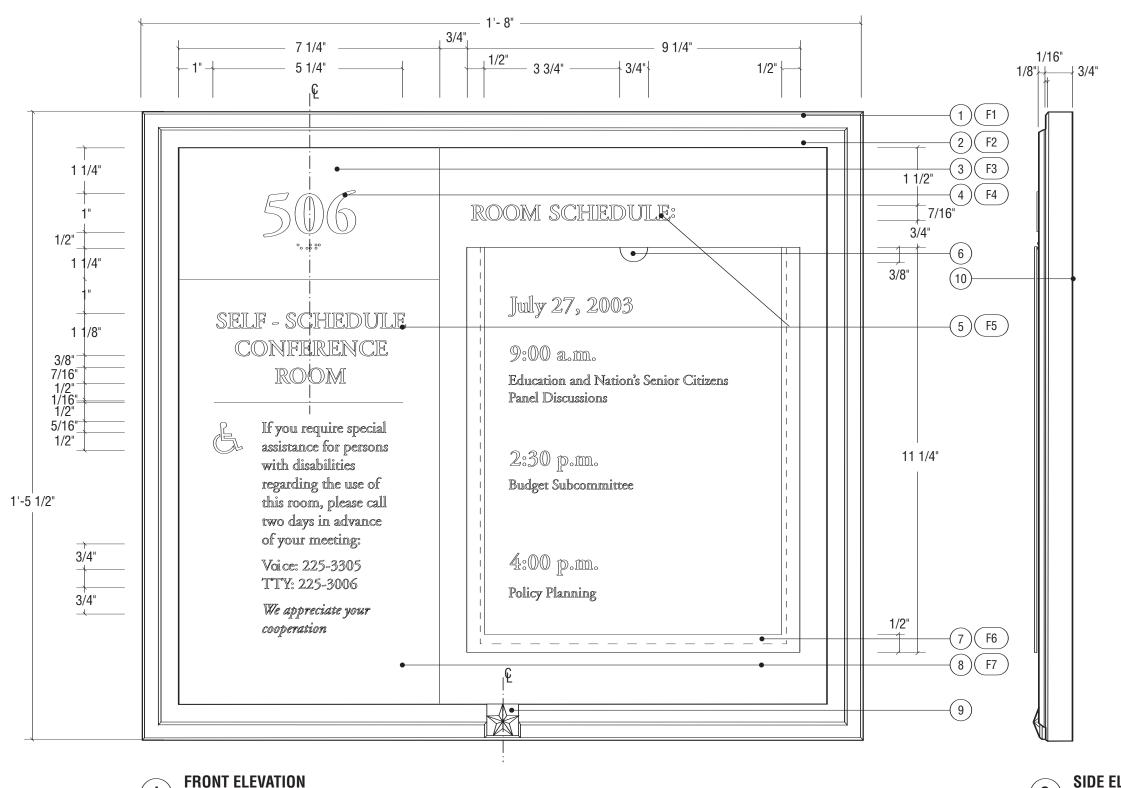

SCALE: 3/8" = 1"

Notes

- 1. Aluminum with mitered cornered and beveled edges.
- 2. Bronze bar stock with mitered cornered and beveled edges.
- 3. Exterior grade photo-polymer plate with 1/32 raised text and Grade II Braille
- 4. Adobe Garamond Bold, as illustrated.
- 5. Adobe Garamond Regular, Italic and Semi-bold, as illustrated. All symbols to match those on Project Symbols sheet.
- 6. Changeable graphic (NIC)
- 7. Non-glare clear acrylic
- 8. White sintra
- 9. Cast bronze prismatic star, mechanically fastened to frame with concealed mechanical fasteners to prevent removal. Wall substraight varies (plaster, marble/granite, wood, etc.), solutions should be specialized or accommodate all while not unnecessarily &/or permanently damaging the wall surface.
- Directory mounts to wall with concealed z-clips. Back bracket to be set in bed of silicone on wall-mounted bracket to prevent movement.
- 11. Note drawing TYPICAL 2 for further dimensions and detail.
- F1. Clear anodized, satin finish, horizontal grain (parallel to frame component) on all sides.
- F2. Clear powder coat finish, horizontal grain (parallel to frame component) on all sides.
- F3. Prime and paint white. Mask raised letters and symbols. Paint background and braille with polyurethane acrylic paint semi-gloss finish to match Benjamin Moore Black Bean Soup 2130-10.
- F4. White
- F5. Adobe Garamond Family to be dropped out, exposing white sintra.
- F6. 1/2" border to be screened to match Benjamin Moore Black Bean Soup 2130-10 on bottom and two sides. 1/4" border of double sided tape under screened border to attach clear acrylic (#7) to sintra (#8). Tape to form gap in which the changeable graphic (#6) will reside.
- F7. Screen print to match Benjamin Moore Black Bean Soup 2130-10. Satin finish.

SIDE ELEVATION

SCALE: 3/8" = 1"



REVISIONS:
NO DESCRIPTION

OWNER

DATE

Architect of the Capitol
Architecture Division Room H2-529
Ford House Office Bldg.
2nd. and D Streets S.W.
Washington, D.C. 20024
TEL: 202-226-1820 FAX: 202-226-1981

ENVIRONMENTAL GRAPHIC DESIGNER

The Douglas|Group 915 Duke Street Alexandria, VA 22202 TEL: 703-549-8050 FAX: 703-549-8053

DESIGN INTENT DRAWINGS FOR SUPERINTENDENT APPROVAL

APPROVAL:

LARRY STOFFELL SUPERINTENDENT SENATE OFFICE BUILDINGS

SIGNATURE

BUILDING NAME
HART SENATE OFFICE BUILDING
PROJECT TITLE
CAPITOL COMPLEX - WAYFINDING

& ADA COMPLIANCE

DRAWING TITLE

T - Self-Schedule Conference Room


SCALE DRAWN BY CHECKED BY
SH/MB
PROJ. NO. IFB NO.
24512.02
CAD FILE NO.
DRAWING NO.

D.18.0

 SHEET
 DATE

 06/14/06

SHEET

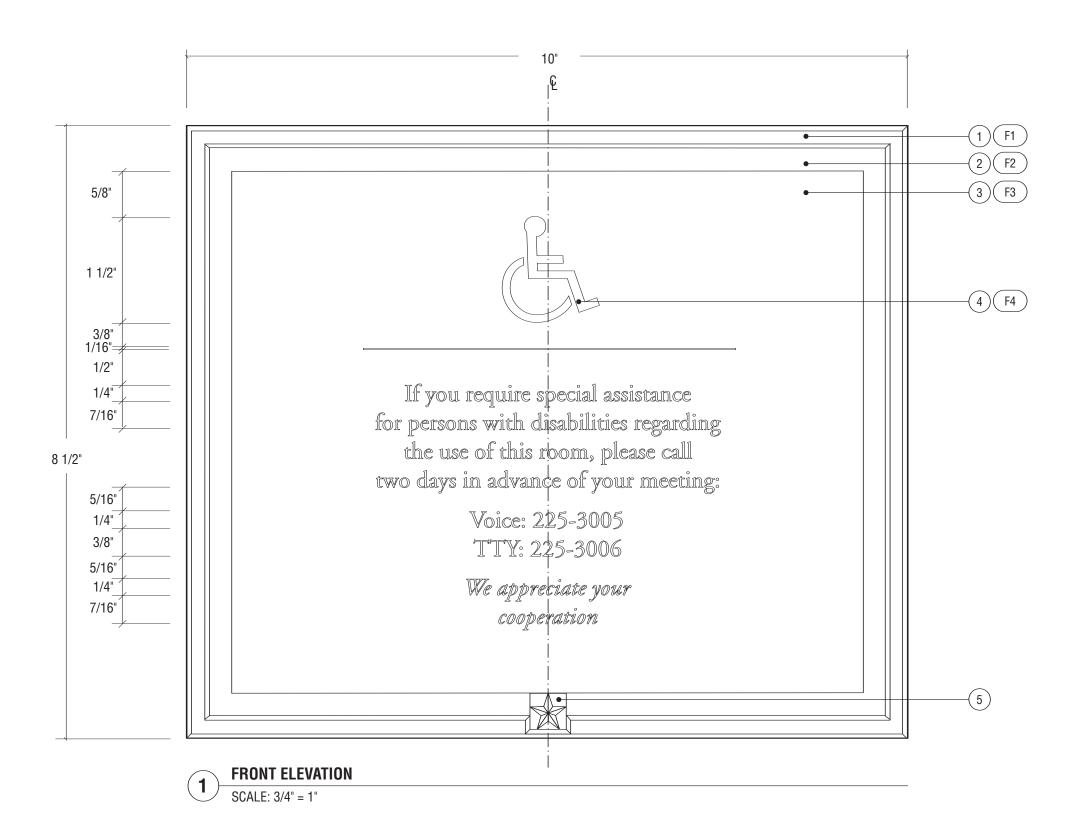

- 1. Aluminum with mitered cornered and beveled edges.
- 2. Bronze bar stock with mitered cornered and beveled edges.
- 3. White sintra panel
- 4. Adobe Garamond Family, as illustrated. All symbols to match those on Project Symbols sheet.
- 5. Cast bronze prismatic star, mechanically fastened to frame with concealed mechanical fasteners to prevent removal
- 6. Note drawing TYPICAL 1 for further dimensions and detail.
- F1. Clear anodized, satin finish, horizontal grain (parallel to frame component) on all sides.
- F2. Clear powder coat finish, horizontal grain (parallel to frame component) on all sides.
- F3. Screen print to match Benjamin Moore Black Bean Soup 2130-10. Satin finish.
- F4. Adobe Garamond Family to be dropped out, exposing white sintra.



REVISIONS:

DESCRIPTION DATE

OWNER

Architect of the Capitol Architecture Division Room H2-529 Ford House Office Bldg. 2nd. and D Streets S.W. Washington, D.C. 20024 TEL: 202-226-1820 FAX: 202-226-1981

ENVIRONMENTAL GRAPHIC DESIGNER

The Douglas|Group 915 Duke Street Alexandria, VA 22202 TEL: 703-549-8050 FAX: 703-549-8053

DESIGN INTENT DRAWINGS FOR SUPERINTENDENT APPROVAL

APPROVAL:

LARRY STOFFELL SUPERINTENDENT SENATE OFFICE BUILDINGS


SIGNATURE

BUILDING NAME HART SENATE OFFICE BUILDING PROJECT TITLE **CAPITOL COMPLEX - WAYFINDING**

& ADA COMPLIANCE DRAWING TITLE

V - Handicap Restriction Plaque

SCALE DRAWN BY CHECKED BY SH/MB PROJ. NO. IFB NO. 24512.02 CAD FILE NO.

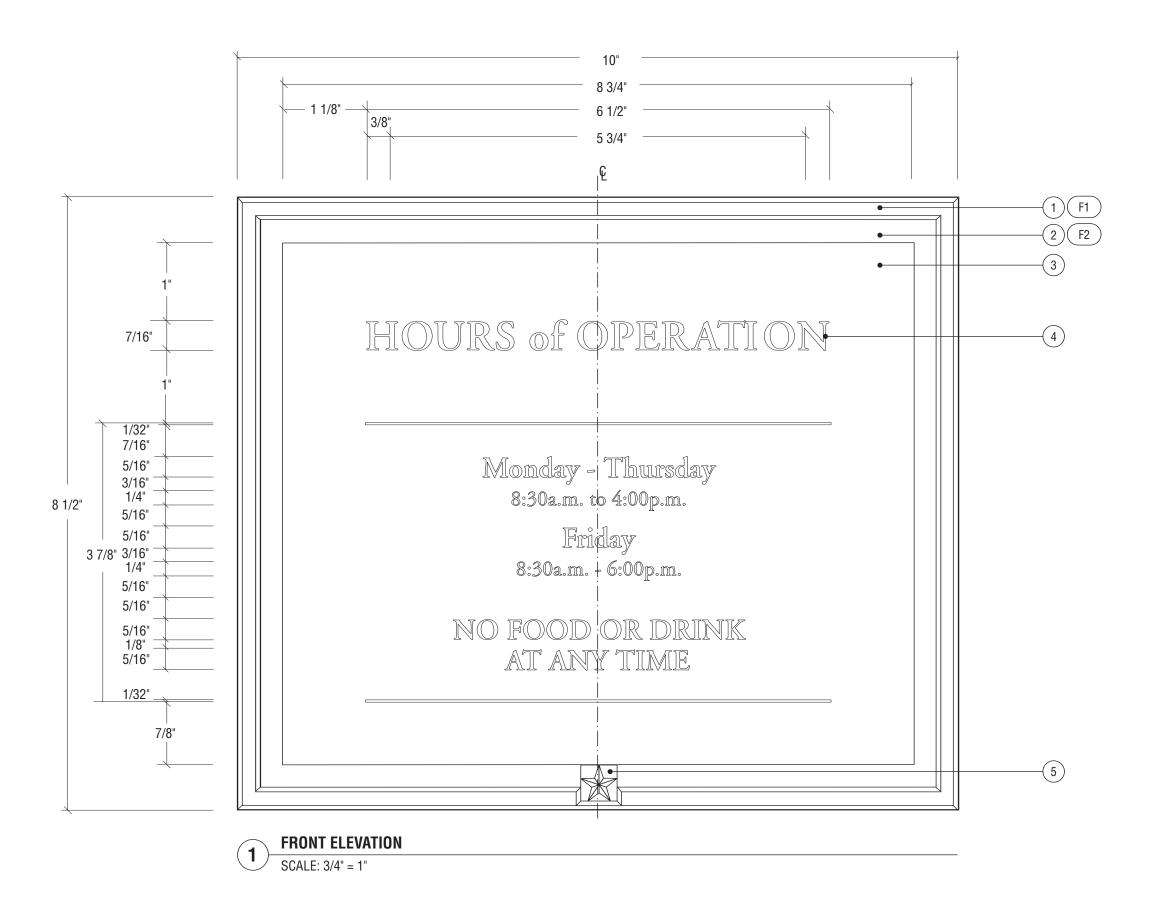

- Aluminum with mitered cornered and beveled edges.
- 2. Bronze bar stock with mitered cornered and beveled edges.
- 3. Non-glare acrylic panel
- 4. Four color process plotted changeable graphic. Adobe Garamond Regular and Semi-bold, as illustrated. All symbols to match those on Project Symbols sheet.
- 5. Cast bronze prismatic star, mechanically fastened to frame with concealed mechanical fasteners to prevent removal.
- 6. Note drawing TYPICAL1 for further dimensions and detail.
- 7. Note drawing ASSEMBLY 2 for "reference only" to fabrication method.
- F1. Clear anodized, satin finish, horizontal grain (parallel to frame component) on all sides.
- F2. Clear powder coat finish, horizontal grain (parallel to frame component) on all sides.

NOTE: LAYOUT ARTWORK FOR THIS SIGN TYPE TO BE PROVIDED BY GRAPHIC DESIGNER.



REVISIONS:
NO DESCRIPTION DATE

OWNER

Architect of the Capitol
Architecture Division Room H2-529
Ford House Office Bldg.
2nd. and D Streets S.W.
Washington, D.C. 20024
TEL: 202-226-1820 FAX: 202-226-1981

ENVIRONMENTAL GRAPHIC DESIGNER

The Douglas|Group 915 Duke Street Alexandria, VA 22202 TEL: 703-549-8050 FAX: 703-549-8053

DESIGN INTENT DRAWINGS FOR SUPERINTENDENT APPROVAL

APPROVAL:

LARRY STOFFELL SUPERINTENDENT SENATE OFFICE BUILDINGS

SIGNATURE

BUILDING NAME

HART SENATE OFFICE BUILDING

PROJECT TITLE

CAPITOL COMPLEX - WAYFINDING
& ADA COMPLIANCE

DRAWING TITLE


W - Hours of Operation

SCALE DRAWN BY CHECKED BY

SH/MB


SH/MB
PROJ. NO. IFB NO.
24512.02
CAD FILE NO.
DRAWING NO.

D.20.0
SHEET

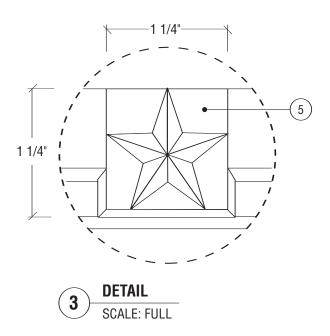

FRONT ELEVATION

SCALE: 1 1/2" = 1'-0"

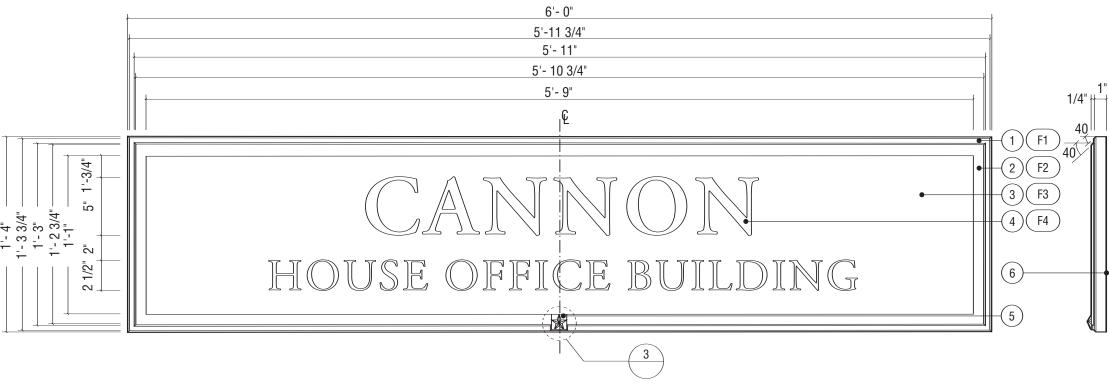

Notes

- 1. Aluminum with mitered cornered and beveled edges.
- 2. Bronze bar stock with mitered cornered and beveled edges.
- 3. White sintra panel
- 4. Adobe Garamond Family as illustrated. All symbols to match those on Project Symbols sheet.
- 5. Cast bronze prismatic star, mechanically fastened to frame with concealed mechanical fasteners to prevent removal.
- 6. Directory mounts to wall with concealed z-clips. Back bracket to be set in bed of silicone on wall-mounted bracket to prevent movement. Wall substraight varies (plaster, marble/granite, wood, etc.), solutions should be specialized or accommodate all while not unnecessarily &/or permanently damaging the wall surface.
- F1. Clear anodized, satin finish, horizontal grain (parallel to frame component) on all sides.
- F2. Clear powder coat finish, horizontal grain (parallel to frame component) on all sides.
- F3. Screen print to match Benjamin Moore Black Bean Soup 2130-10. Satin finish.
- F4. Adobe Garamond Family to be dropped out, exposing white sintra.

SIDE ELEVATION

SCALE: 1 1/2" = 1'-0"



REVISIONS:

DESCRIPTION DATE

OWNER

Architect of the Capitol
Architecture Division Room H2-529
Ford House Office Bldg.
2nd. and D Streets S.W.
Washington, D.C. 20024
TEL: 202-226-1820 FAX: 202-226-1981

ENVIRONMENTAL GRAPHIC

DESIGNER

The Douglas|Group 915 Duke Street Alexandria, VA 22202 TEL: 703-549-8050 FAX: 703-549-8053

DESIGN INTENT DRAWINGS FOR SUPERINTENDENT APPROVAL

APPROVAL:

LARRY STOFFELL SUPERINTENDENT SENATE OFFICE BUILDINGS

SIGNATURE

BUILDING NAME
HART SENATE OFFICE BUILDING
PROJECT TITLE

CAPITOL COMPLEX - WAYFINDING & ADA COMPLIANCE

DRAWING TITLE

GG - Building Announce./Direct.


SCALE DRAWN BY CHECKED BY
SH/MB
PROJ. NO. IFB NO.
24512.02
CAD FILE NO.
DRAWING NO.

D.21.0

SHEET DATE 06/14/06

In the Douglas Group. All rights reserved. No part of this document may be reproduced or utilized in any form without prior written authorization from The Douglas Group. This document serves as a device to communicate design intent only. Fabrication and installation of the products represented herein will be derived from shop drawings produced by the contracted fabricator.



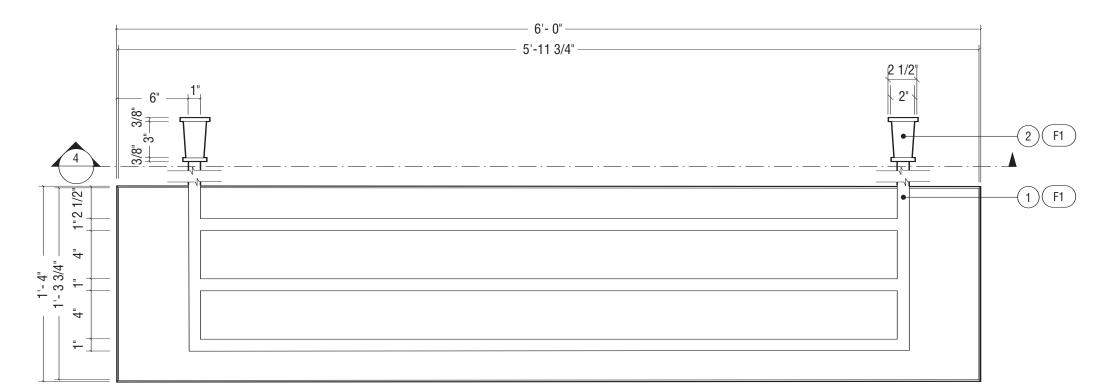

REAR ELEVATION
SCALE: 1 1/2" = 1'-0"



FRONT ELEVATION

SCALE: 1 1/2" = 1'-0"



Notes

- 1. 1" square tubular welded metal frame
- 2. Sleeve
- 3. Secure to ceiling using hidden attachments.
- F1. Paint to match Benjamin Moore Black Bean Soup 2130-10. Satin finish.



REVISIONS:

NO DESCRIPTION DATE

OWNER

Architect of the Capitol
Architecture Division Room H2-529
Ford House Office Bldg.
2nd. and D Streets S.W.
Washington, D.C. 20024
TEL: 202-226-1820 FAX: 202-226-1981

ENVIRONMENTAL GRAPHIC DESIGNER

The Douglas|Group 915 Duke Street Alexandria, VA 22202 TEL: 703-549-8050 FAX: 703-549-8053

DESIGN INTENT DRAWINGS FOR SUPERINTENDENT APPROVAL

APPROVAL:

BUILDING NAME


LARRY STOFFELL SUPERINTENDENT SENATE OFFICE BUILDINGS

SIGNATURE

HART SENATE OFFICE BUILDING
PROJECT TITLE
CAPITOL COMPLEX - WAYFINDING
& ADA COMPLIANCE
DRAWING TITLE
GG - Building Announce./Direct.
SCALE DRAWN BY CHECKED BY

SCALE DRAWN BY CHECKED BY
SH/MB
PROJ. NO. IFB NO.
24512.02
CAD FILE NO.
DRAWING NO.

D.21.1

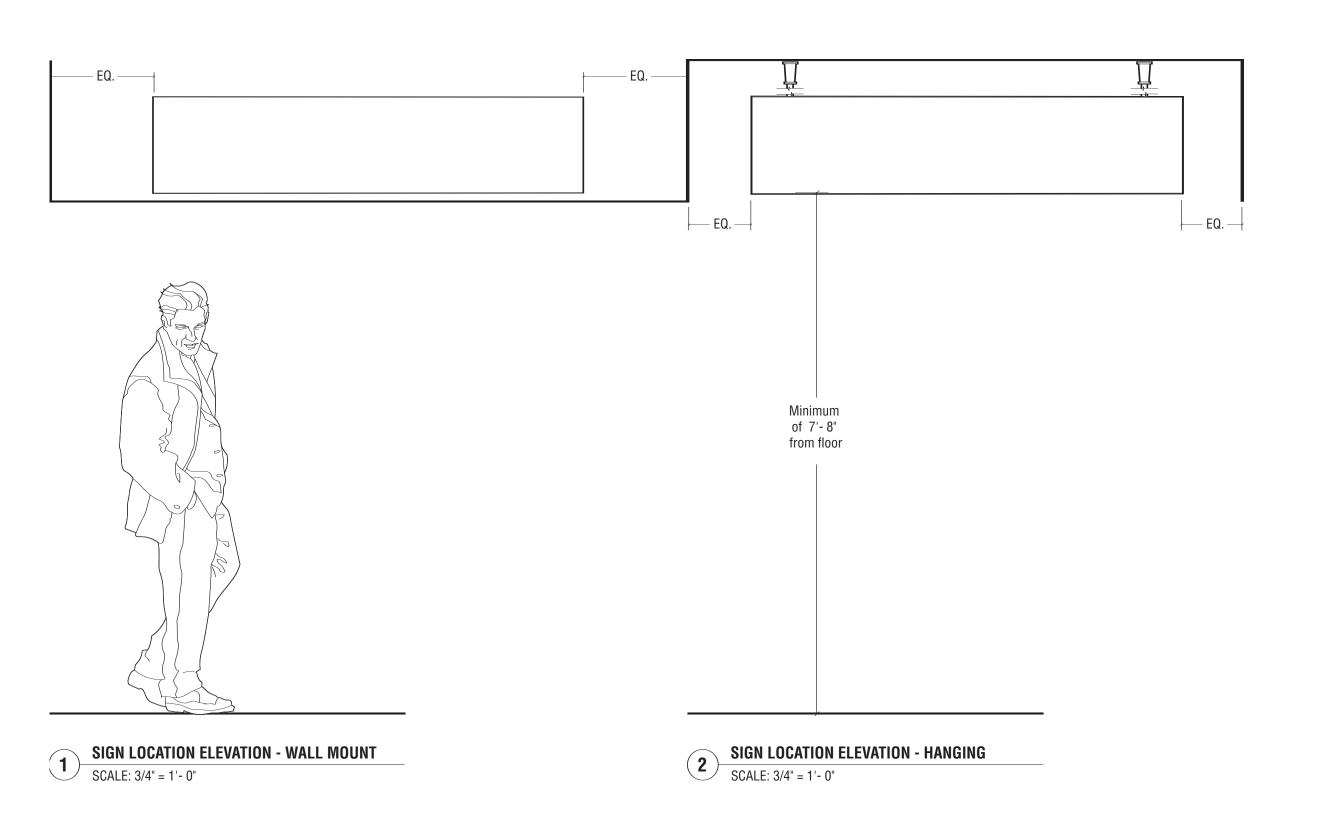



REVISIONS:
NO DESCRIPTION DATE

OWNER

Architect of the Capitol
Architecture Division Room H2-529
Ford House Office Bldg.
2nd. and D Streets S.W.
Washington, D.C. 20024
TEL: 202-226-1820 FAX: 202-226-1981

ENVIRONMENTAL GRAPHIC DESIGNER

The Douglas|Group 915 Duke Street Alexandria, VA 22202 TEL: 703-549-8050 FAX: 703-549-8053

DESIGN INTENT DRAWINGS FOR SUPERINTENDENT APPROVAL

APPROVAL:

LARRY STOFFELL SUPERINTENDENT SENATE OFFICE BUILDINGS

SIGNATURE

BUILDING NAME
HART SENAT

HART SENATE OFFICE BUILDING PROJECT TITLE

CAPITOL COMPLEX - WAYFINDING


& ADA COMPLIANCE

DRAWING TITLE

GG - Building Announce./Direct.

SCALE DRAWN BY CHECKED BY
SH/MB
PROJ. NO. IFB NO.
24512.02
CAD FILE NO.
DRAWING NO.

D.21.2

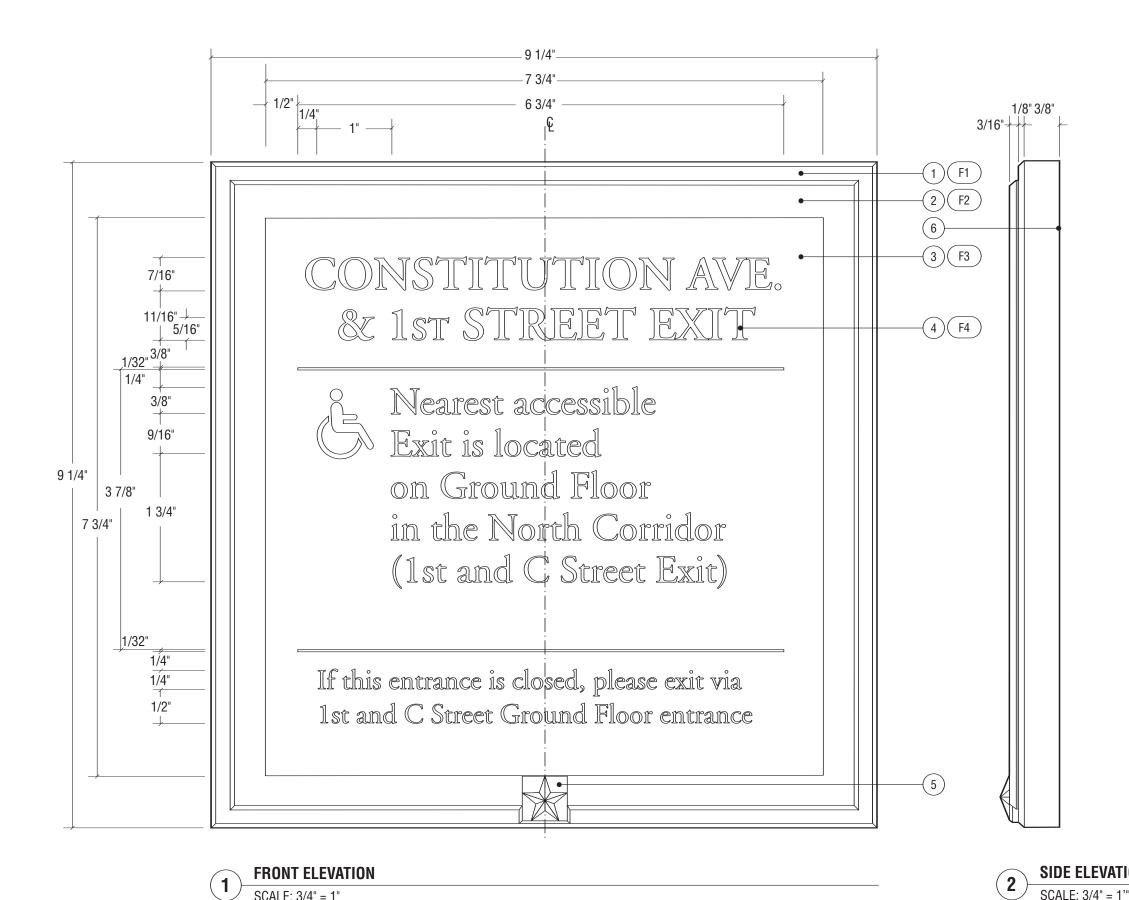

- Aluminum with mitered cornered and beveled edges.
- 2. Bronze bar stock with mitered cornered and beveled edges.
- 3. White sintra panel
- 4. Adobe Garamond Family as illustrated. All symbols to match those on Project Symbols sheet.
- 5. Cast bronze prismatic star, mechanically fastened to frame with concealed mechanical fasteners to prevent removal
- 6. Sign mounts with double sided 3M VHB tape and silicone.
- 7. Note drawing TYPICAL 4 for further dimensions and detail.
- F1. Clear anodized, satin finish, horizontal grain (parallel to frame component) on all sides.
- F2. Clear powder coat finish, horizontal grain (parallel to frame component) on all sides.
- F3. Screen print to match Benjamin Moore Black Bean Soup 2130-10. Satin finish.
- F4. Adobe Garamond Family to be dropped out, exposing white sintra.



REVISIONS:

NO DESCRIPTION DATE

OWNER

Architect of the Capitol
Architecture Division Room H2-529
Ford House Office Bldg.
2nd. and D Streets S.W.
Washington, D.C. 20024
TEL: 202-226-1820 FAX: 202-226-1981

ENVIRONMENTAL GRAPHIC DESIGNER

The Douglas|Group 915 Duke Street Alexandria, VA 22202 TEL: 703-549-8050 FAX: 703-549-8053

DESIGN INTENT DRAWINGS FOR SUPERINTENDENT APPROVAL

APPROVAL:

BUILDING NAME

LARRY STOFFELL SUPERINTENDENT SENATE OFFICE BUILDINGS

SIGNATURE


HART SENATE OFFICE BUILDING
PROJECT TITLE
CAPITOL COMPLEX - WAYFINDING
& ADA COMPLIANCE
DRAWING TITLE
HH - Exit Information
SCALE DRAWN BY CHECKED BY

SCALE DRAWN BY CHECKED BY
SH/MB
PROJ. NO. IFB NO.
24512.02
CAD FILE NO.
DRAWING NO.

D.22.0

SHEET DATE 06/14/06

I © The Douglas Group. All rights reserved. No part of this document may be reproduced or utilized in any form without prior written authorization from The Douglas|Group. This document only. Fabrication and installation of the products represented herein will be derived from shop drawings produced by the contracted fabricator.

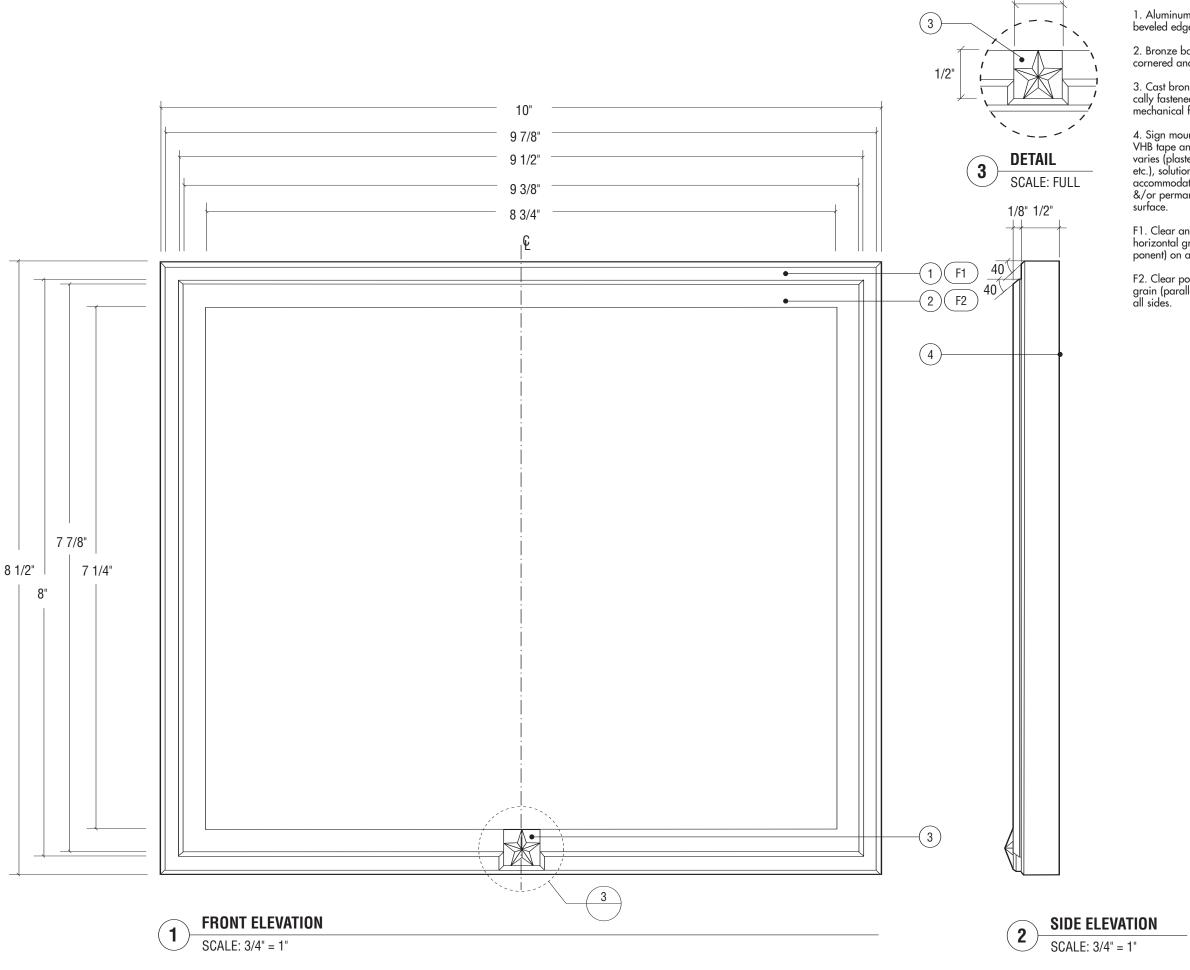

- Aluminum with mitered cornered and beveled edges.
- 2. Bronze bar stock with mitered cornered and beveled edges.
- 3. Cast bronze prismatic star, mechanically fastened to frame with concealed mechanical fasteners to prevent removal.
- 4. Sign mounts with double sided 3M VHB tape and silicone. Wall substraight varies (plaster, marble/granite, wood, etc.), solutions should be specialized or accommodate all while not unnecessarily &/or permanently damaging the wall surface.
- F1. Clear anodized, satin finish, horizontal grain (parallel to frame component) on all sides.
- F2. Clear powder coat finish, horizontal grain (parallel to frame component) on all sides.



REVISIONS:
NO DESCRIPTION DATE

OWNER

Architect of the Capitol
Architecture Division Room H2-529
Ford House Office Bldg.
2nd. and D Streets S.W.
Washington, D.C. 20024
TEL: 202-226-1820 FAX: 202-226-1981

ENVIRONMENTAL GRAPHIC DESIGNER

The Douglas|Group 915 Duke Street Alexandria, VA 22202 TEL: 703-549-8050 FAX: 703-549-8053

DESIGN INTENT DRAWINGS FOR SUPERINTENDENT APPROVAL

APPROVAL:

BUILDING NAME

LARRY STOFFELL SUPERINTENDENT SENATE OFFICE BUILDINGS


SIGNATURE

HART SENATE OFFICE BUILDING
PROJECT TITLE
CAPITOL COMPLEX - WAYFINDING
& ADA COMPLIANCE
DRAWING TITLE

D, V & W - Typical Plaque

SCALE DRAWN BY CHECKED BY
SH/MB
PROJ. NO. IFB NO.
24512.02
CAD FILE NO.

TYPICAL 1.0

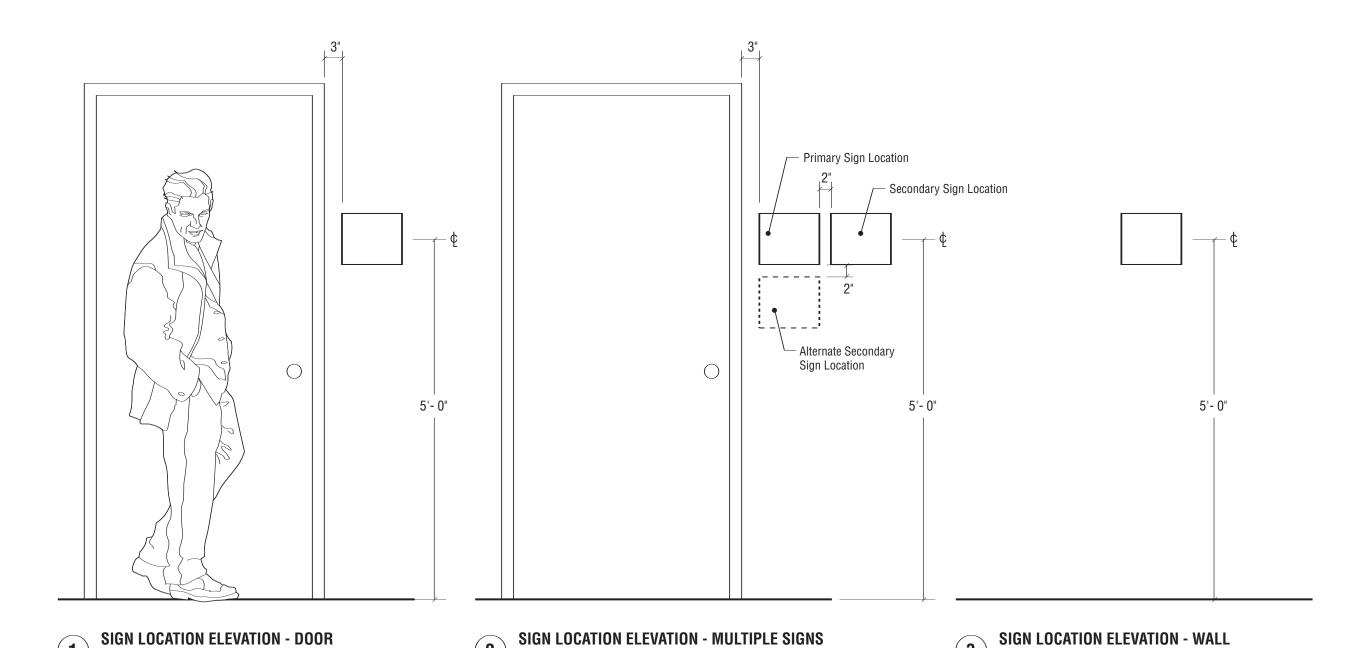

SCALE: 3/4" = 1'- 0"

SCALE: 3/4" = 1'- 0"



REVISIONS:
NO DESCRIPTION DATE

OWNER

Architect of the Capitol Architecture Division Room H2-529 Ford House Office Bldg. 2nd. and D Streets S.W. Washington, D.C. 20024

TEL: 202-226-1820 FAX: 202-226-1981

ENVIRONMENTAL GRAPHIC DESIGNER

The Douglas|Group 915 Duke Street Alexandria, VA 22202 TEL: 703-549-8050 FAX: 703-549-8053

DESIGN INTENT DRAWINGS FOR SUPERINTENDENT APPROVAL

APPROVAL:

LARRY STOFFELL SUPERINTENDENT SENATE OFFICE BUILDINGS

SIGNATURE

BUILDING NAME

HART SENATE OFFICE BUILDING PROJECT TITLE

CAPITOL COMPLEX - WAYFINDING & ADA COMPLIANCE

DRAWING TITLE


D, V & W - Typical Plaque

SCALE DRAWN BY CHECKED BY SH/MB PROJ. NO. IFB NO.

24512.02 CAD FILE NO. DRAWING NO.

SHEET DATE

SCALE: 3/4" = 1'- 0"

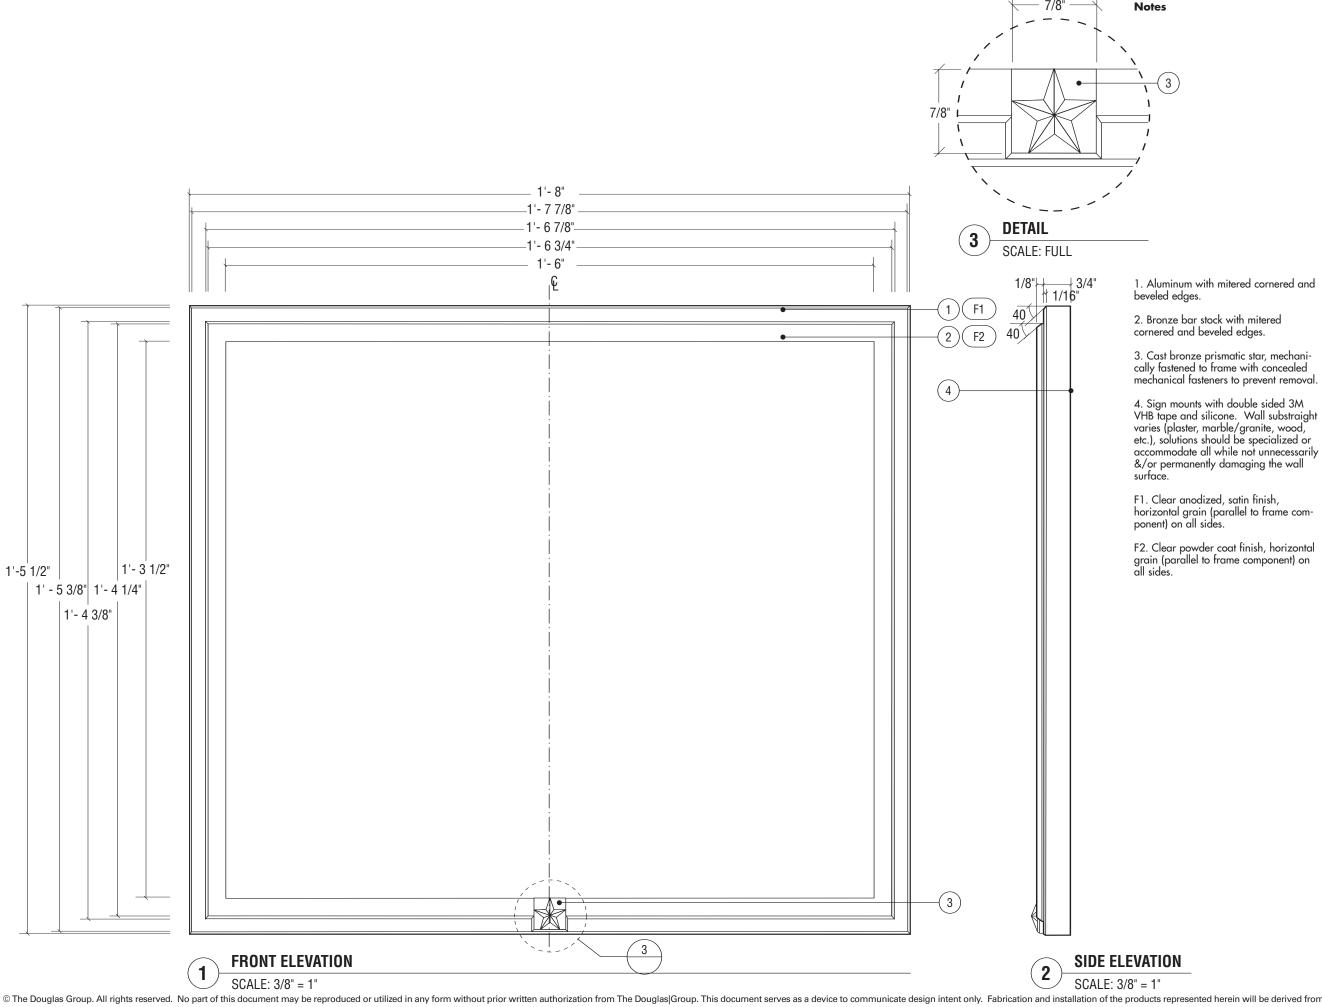



REVISIONS: DESCRIPTION DATE

OWNER

Architect of the Capitol Architecture Division Room H2-529 Ford House Office Bldg. 2nd. and D Streets S.W. Washington, D.C. 20024 TEL: 202-226-1820 FAX: 202-226-1981

ENVIRONMENTAL GRAPHIC DESIGNER

The Douglas|Group 915 Duke Street Alexandria, VA 22202 TEL: 703-549-8050 FAX: 703-549-8053

DESIGN INTENT DRAWINGS FOR SUPERINTENDENT APPROVAL

APPROVAL:

BUILDING NAME

CAD FILE NO.


LARRY STOFFELL SUPERINTENDENT SENATE OFFICE BUILDINGS

SIGNATURE

HART SENATE OFFICE BUILDING

PROJECT TITLE **CAPITOL COMPLEX - WAYFINDING** & ADA COMPLIANCE DRAWING TITLE O, S, &T -Typical Plaque SCALE DRAWN BY CHECKED BY SH/MB PROJ. NO. IFB NO. 24512.02

SHEET DATE

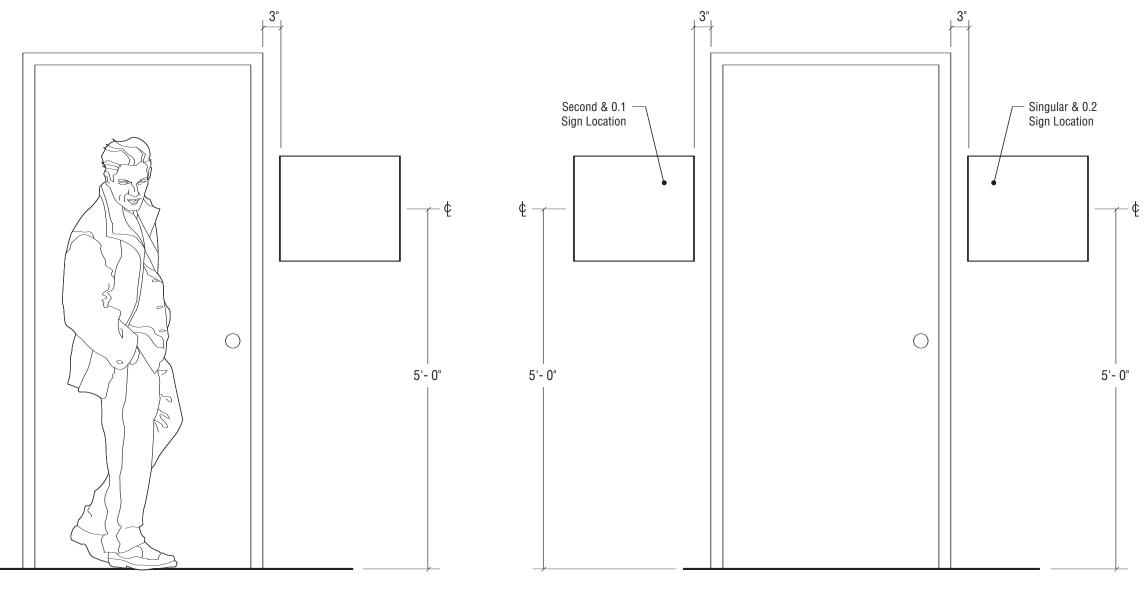

SIGN LOCATION ELEVATION - DOOR

SIGN LOCATION ELEVATION - MULTIPLE SIGNS



REVISIONS:
NO DESCRIPTION

DATE

OWNER

Architect of the Capitol Architecture Division Room H2-529 Ford House Office Bldg. 2nd. and D Streets S.W. Washington, D.C. 20024 TEL: 202-226-1820 FAX: 202-226-1981

ENVIRONMENTAL GRAPHIC DESIGNER

The Douglas|Group 915 Duke Street Alexandria, VA 22202 TEL: 703-549-8050 FAX: 703-549-8053

DESIGN INTENT DRAWINGS FOR SUPERINTENDENT APPROVAL

APPROVAL:

LARRY STOFFELL SUPERINTENDENT SENATE OFFICE BUILDINGS

SIGNATURE

BUILDING NAME

HART SENATE OFFICE BUILDING PROJECT TITLE

CAPITOL COMPLEX - WAYFINDING & ADA COMPLIANCE


DRAWING TITLE

O, S, &T - Typical Plaque

SCALE DRAWN BY CHECKED BY PROJ. NO. IFB NO. 24512.02

CAD FILE NO. DRAWING NO.

SHEET DATE

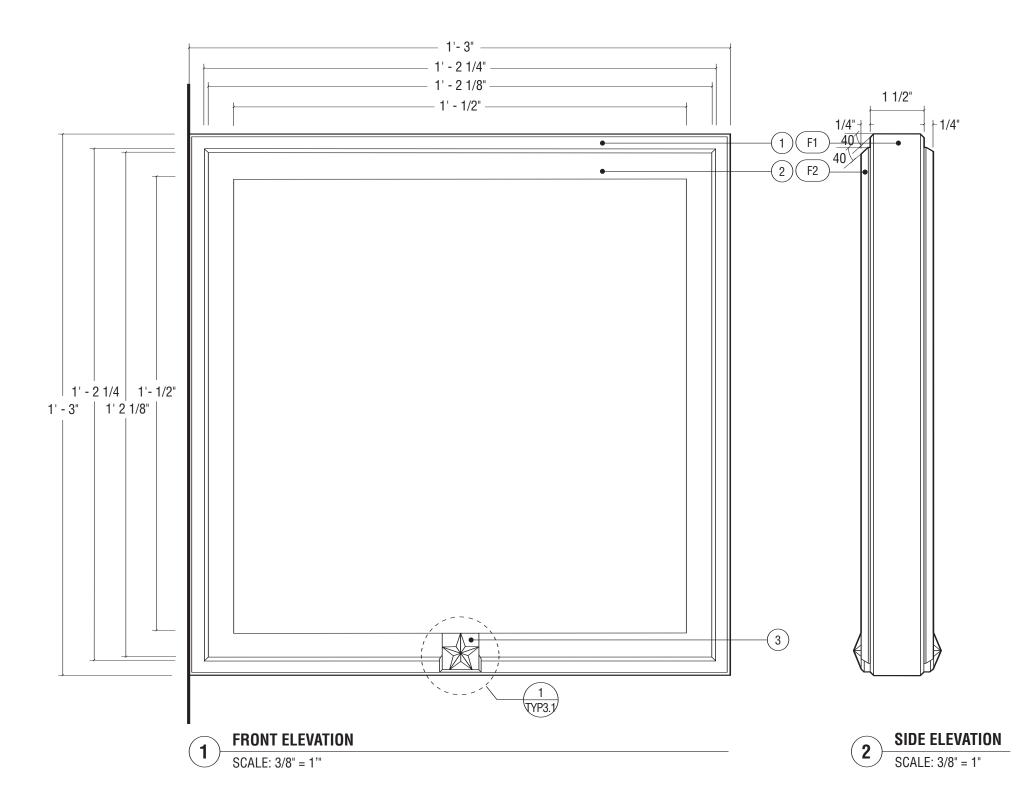

- 1. Aluminum with mitered cornered and beveled edges.
- 2. Bronze bar stock with mitered cornered and beveled edges.
- 3. Cast bronze prismatic star, mechanically fastened to frame with concealed mechanical fasteners to prevent removal.
- 4. Sign mounts to wall with hidden mechanical devices. Wall substraight varies (plaster, marble/granite, wood, etc.), solutions should be specialized or accommodate all while not unnecessarily &/or permanently damaging the wall surface.
- F1. Clear anodized, satin finish, horizontal grain (parallel to frame component) on all sides.
- F2. Clear powder coat finish, horizontal grain (parallel to frame component) on all sides.



REVISIONS:

DESCRIPTION DATE

OWNER

Architect of the Capitol Architecture Division Room H2-529 Ford House Office Bldg. 2nd. and D Streets S.W. Washington, D.C. 20024 TEL: 202-226-1820 FAX: 202-226-1981

ENVIRONMENTAL GRAPHIC DESIGNER

The Douglas|Group 915 Duke Street Alexandria, VA 22202 TEL: 703-549-8050 FAX: 703-549-8053

DESIGN INTENT DRAWINGS FOR SUPERINTENDENT APPROVAL

APPROVAL:

LARRY STOFFELL SUPERINTENDENT SENATE OFFICE BUILDINGS

SIGNATURE

BUILDING NAME

HART SENATE OFFICE BUILDING PROJECT TITLE

CAPITOL COMPLEX - WAYFINDING

& ADA COMPLIANCE


DRAWING TITLE

H, H.1 & I - Typical Plaque


SCALE DRAWN BY CHECKED BY SH/MB PROJ. NO. IFB NO. 24512.02 CAD FILE NO.


SHEET DATE

© The Douglas Group. All rights reserved. No part of this document may be reproduced or utilized in any form without prior written authorization from The Douglas|Group. This document may be reproduced by the contracted fabricator.

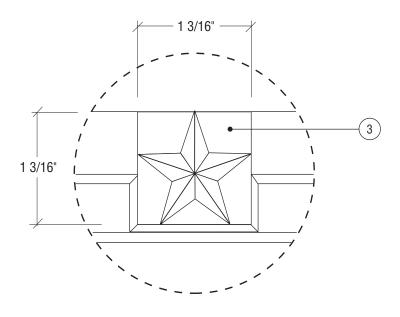

1 DETAIL
SCALE: FULL

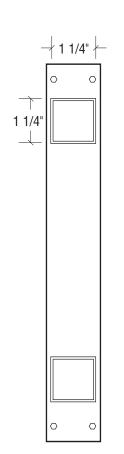

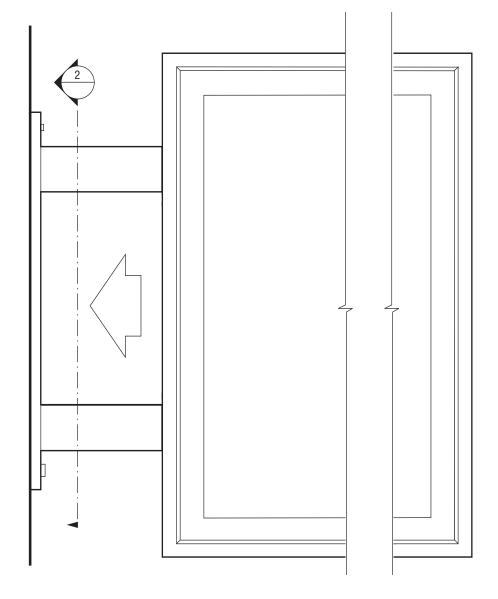

MOUNTING DETAIL

SCALE: 3/8" = 1"

SIDE ELEVATION / MOUNTING PLATE

SCALE: 3/8" = 1"

Notes

 Cast bronze prismatic star, mechanically fastened to frame with concealed mechanical fasteners to prevent removal.



REVISIONS:
NO DESCRIPTION DATE

OWNER

Architect of the Capitol
Architecture Division Room H2-529
Ford House Office Bldg.
2nd. and D Streets S.W.
Washington, D.C. 20024
TEL: 202-226-1820 FAX: 202-226-1981

ENVIRONMENTAL GRAPHIC DESIGNER

The Douglas|Group 915 Duke Street Alexandria, VA 22202 TEL: 703-549-8050 FAX: 703-549-8053

DESIGN INTENT DRAWINGS FOR SUPERINTENDENT APPROVAL

APPROVAL:

BUILDING NAME

LARRY STOFFELL SUPERINTENDENT SENATE OFFICE BUILDINGS

SIGNATURE

HART SENATE OFFICE BUILDING
PROJECT TITLE
CAPITOL COMPLEX - WAYFINDING
& ADA COMPLIANCE
DRAWING TITLE
H, H.1 & I - Typical Plaque


SCALE DRAWN BY CHECKED BY
SH/MB
PROJ. NO. IFB NO.
24512.02
CAD FILE NO.
DRAWING NO.

TYPICAL 3.1

 SHEET
 DATE

 06/14/06

NOTE: DOORS ARE SHOWN FOR INDICATION OF LATERAL DISPLACEMENT ONLY - NOT INDICATIVE OF ACTUAL DOOR DIMENSIONS OR CONDITIONS AT INSTALLATION. AT LOCATIONS WHERE A PROJECTING SIGN IS PROGRAMMED ABOVE A ROOM IDENTIFICATION SIGN, THE PROJECTING SIGN TO BE ALIGNED FLUSH WITH THE EDGE OF THE IDENTIFICATION SIGN CLOSEST TO THE DOOR JAMB (TYPICALLY 3" FROM FRAMING).

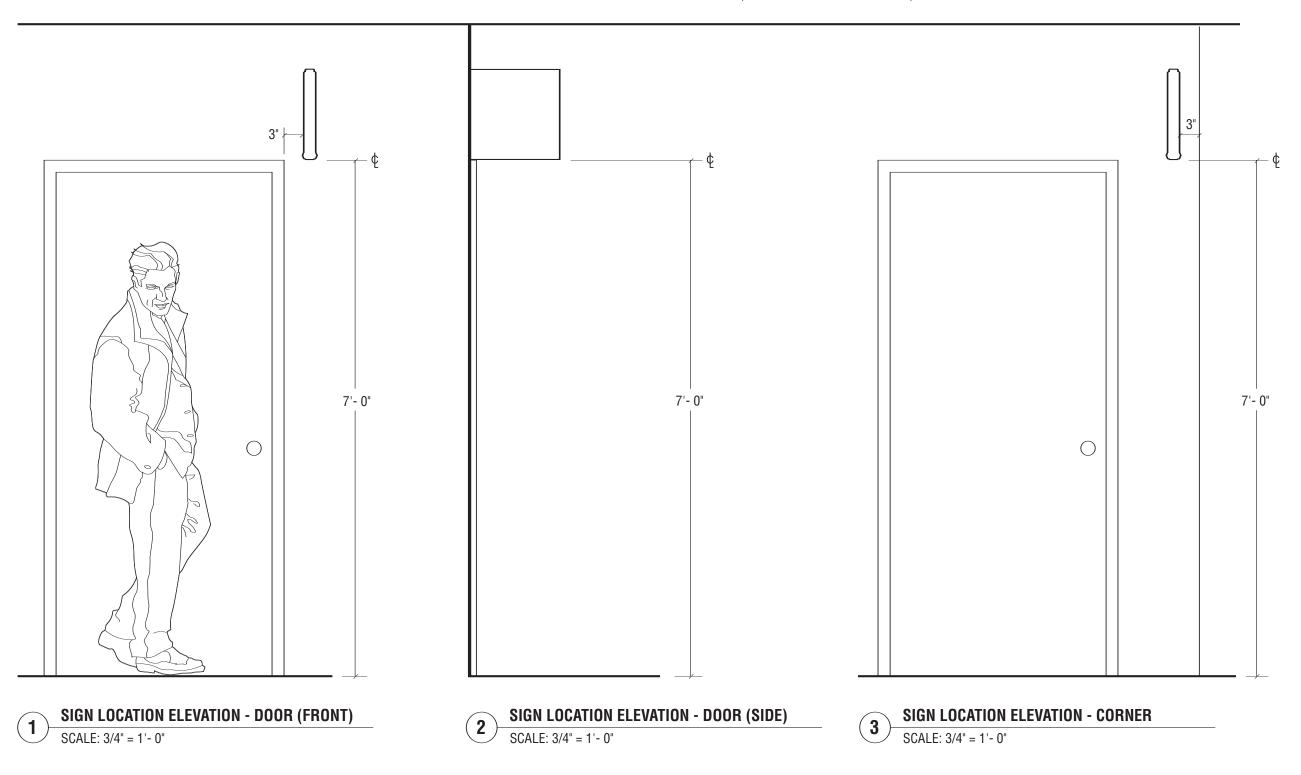



REVISIONS:
NO DESCRIPTION DATE

OWNER

Architect of the Capitol
Architecture Division Room H2-529
Ford House Office Bldg.
2nd. and D Streets S.W.
Washington, D.C. 20024
TEL: 202-226-1820 FAX: 202-226-1981

ENVIRONMENTAL GRAPHIC DESIGNER

The Douglas|Group 915 Duke Street Alexandria, VA 22202 TEL: 703-549-8050 FAX: 703-549-8053

DESIGN INTENT DRAWINGS FOR SUPERINTENDENT APPROVAL

APPROVAL:

LARRY STOFFELL SUPERINTENDENT SENATE OFFICE BUILDINGS

SIGNATURE BUILDING NAME

HART SENATE OFFICE BUILDING


PROJECT TITLE
CAPITOL COMPLEX - WAYFINDING

& ADA COMPLIANCE DRAWING TITLE

H, H.1 & I - Typical Plaque

SCALE DRAWN BY CHECKED BY
SH/MB
PROJ. NO. IFB NO.
24512.02
CAD FILE NO.
DRAWING NO.

TYPICAL 3.2

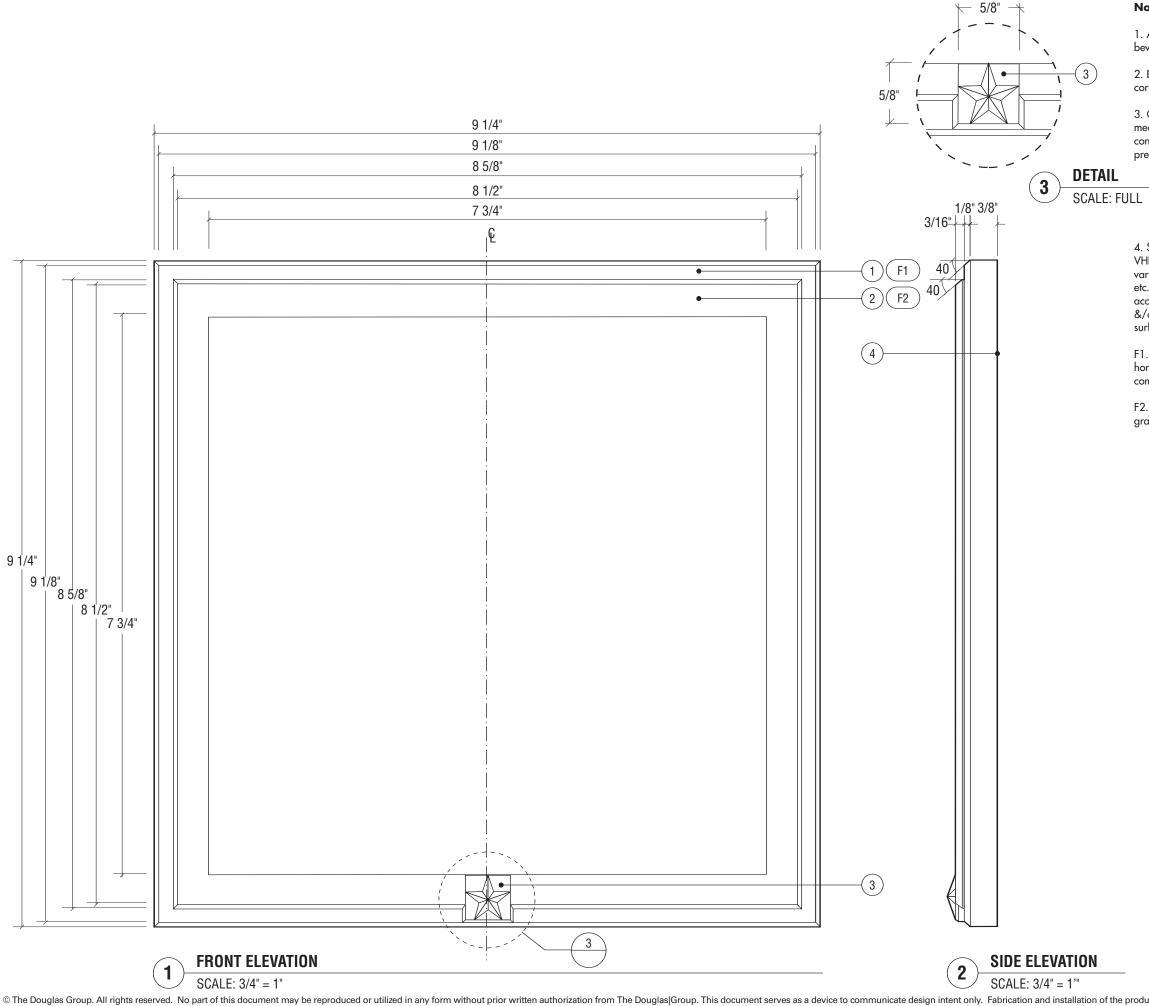



- 1. Aluminum with mitered cornered and beveled edges.
- 2. Bronze bar stock with mitered cornered and beveled edges.
- 3. Cast bronze prismatic star, mechanically fastened to frame with concealed mechanical fasteners to prevent removal.
- 4. Sign mounts with double sided 3M VHB tape and silicone. Wall substraigh varies (plaster, marble/granite, wood, etc.), solutions should be specialized or accommodate all while not unnecessarily &/or permanently damaging the wall surface.
- F1. Clear anodized, satin finish, horizontal grain (parallel to frame component) on all sides.
- F2. Clear powder coat finish, horizontal grain on all sides.



REVISIONS: DESCRIPTION DATE

OWNER

Architect of the Capitol Architecture Division Room H2-529 Ford House Office Bldg. 2nd. and D Streets S.W. Washington, D.C. 20024 TEL: 202-226-1820 FAX: 202-226-1981

ENVIRONMENTAL GRAPHIC DESIGNER

The Douglas|Group 915 Duke Street Alexandria, VA 22202 TEL: 703-549-8050 FAX: 703-549-8053

DESIGN INTENT DRAWINGS FOR SUPERINTENDENT APPROVAL

APPROVAL:

BUILDING NAME

LARRY STOFFELL SUPERINTENDENT SENATE OFFICE BUILDINGS

SIGNATURE


HART SENATE OFFICE BUILDING PROJECT TITLE **CAPITOL COMPLEX - WAYFINDING** & ADA COMPLIANCE DRAWING TITLE

L, M, & HH - Typical Plaque SCALE DRAWN BY CHECKED BY

SH/MB PROJ. NO. IFB NO. 24512.02 CAD FILE NO.

SHEET

DATE

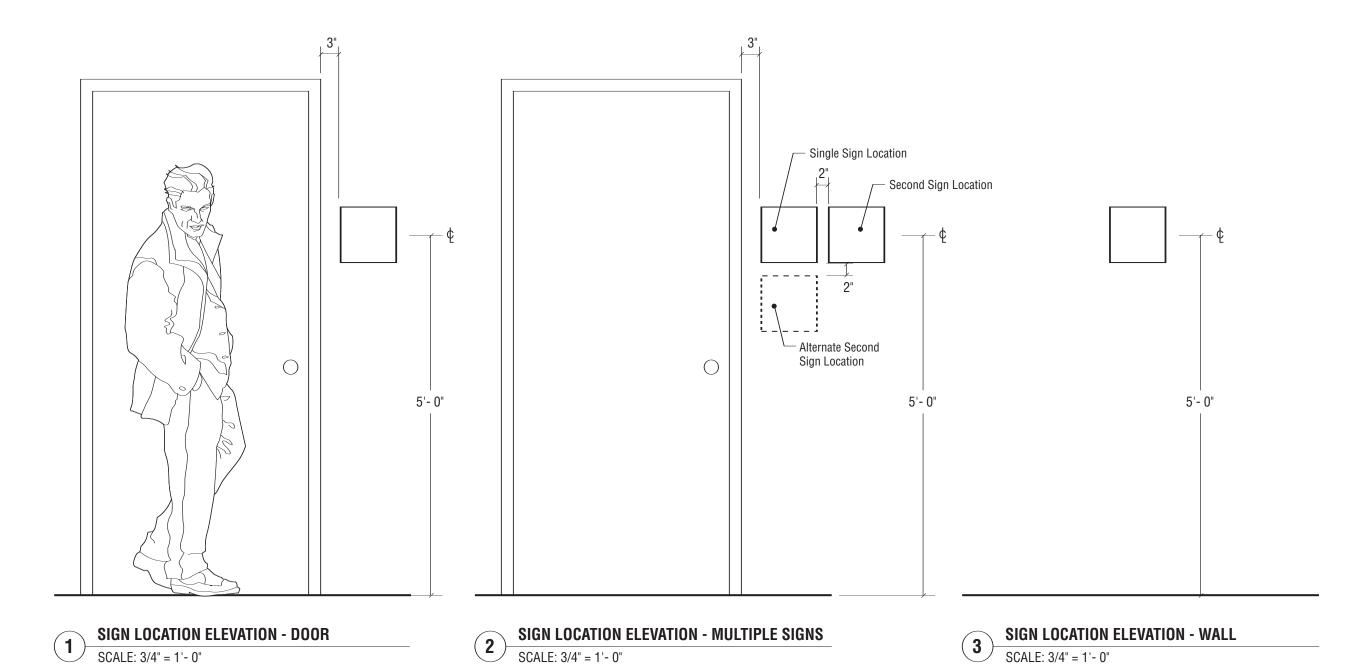

1793 ☆

REVISIONS:
NO DESCRIPTION DATE

OWNER

Architect of the Capitol Architecture Division Room H2-529 Ford House Office Bldg. 2nd. and D Streets S.W. Washington, D.C. 20024

TEL: 202-226-1820 FAX: 202-226-1981

ENVIRONMENTAL GRAPHIC DESIGNER

The Douglas|Group 915 Duke Street Alexandria, VA 22202 TEL: 703-549-8050 FAX: 703-549-8053

DESIGN INTENT DRAWINGS FOR SUPERINTENDENT APPROVAL

APPROVAL:

LARRY STOFFELL SUPERINTENDENT SENATE OFFICE BUILDINGS

SIGNATURE

BUILDING NAME

HART SENATE OFFICE BUILDING PROJECT TITLE

CAPITOL COMPLEX - WAYFINDING & ADA COMPLIANCE

DRAWING TITLE


L, M, & HH - Typical Plaque

SCALE DRAWN BY CHECKED BY SH/MB PROJ. NO. IFB NO.

24512.02

CAD FILE NO. DRAWING NO.

SHEET DATE

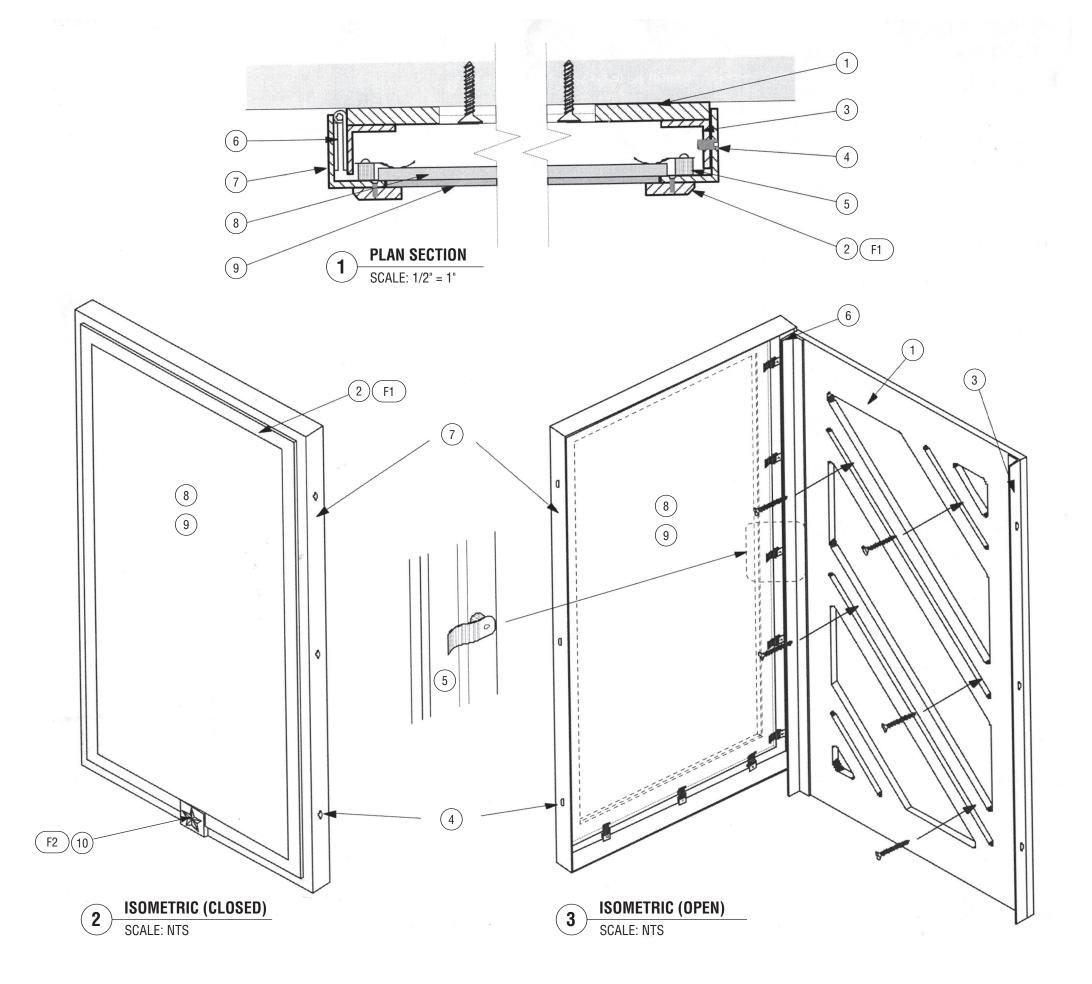

- 3/8" aluminum back plate with beveled slots to hold flat head mounting screws.
- Bronze frame with star, 1/4" x 1" with beveled outside edge and mitered cornered. Silver solder all joints. Mount to aluminum frame with screws from back in tapped holes.
- 3. 1" x 1" aluminum angle at each side, welded to backplate.
- 4. Tamper resistant screws at right side to hold case closed.
- 5. Graphic panels held in place with steel clips. Turn clips to remove panel.
- 6. Continuous piano hinge at left side.
- Case frame. Welded aluminum angle. Grind all welds smooth with a clear anodized, satin finish, horizontal grain.
- 8. Backer panel behind graphic, 1/4" Sintra.
- Front acrylic panel, 1/8" clear nonglare.
- Cast bronze prismatic star, mechanically fastened to frame with concealed mechanical fasteners to prevent removal.
- 11. Four color process plotted graphic
- F1. Clear powder coat finish on frame, horizontal grain (parallel to frame component) and polished finish on the bevel and return.
- F2. Clear powder coat finish.



REVISIONS:
NO DESCRIPTION DATE

OWNER

Architect of the Capitol
Architecture Division Room H2-529
Ford House Office Bldg.
2nd. and D Streets S.W.
Washington, D.C. 20024
TEL: 202-226-1820 FAX: 202-226-1981

ENVIRONMENTAL GRAPHIC DESIGNER

The Douglas|Group 915 Duke Street Alexandria, VA 22202 TEL: 703-549-8050 FAX: 703-549-8053

DESIGN INTENT DRAWINGS FOR SUPERINTENDENT APPROVAL

APPROVAL:

LARRY STOFFELL SUPERINTENDENT SENATE OFFICE BUILDINGS

SIGNATURE

BUILDING NAME
HART SENATE OFFICE BUILDING
PROJECT TITLE


CAPITOL COMPLEX - WAYFINDING & ADA COMPLIANCE

DRAWING TITLE

F - Assembly Option

SCALE DRAWN BY CHECKED BY
SH/MB
PROJ. NO. IFB NO.
24512.02
CAD FILE NO.
DRAWING NO.

ASSEMBLY

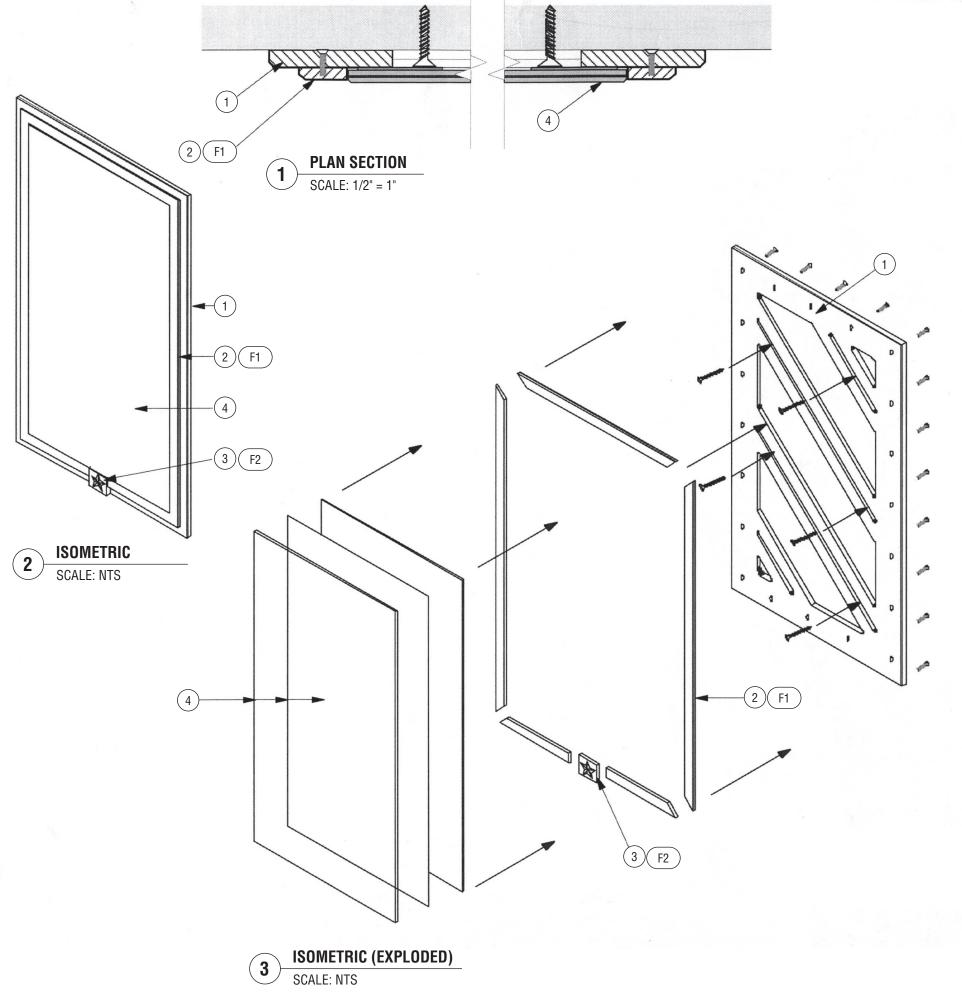

- 3/8" aluminum back plate with beveled slots to hold flat head mounting screws and 1/8" bevel around outside edge.
- Bronze frame 1/4" x 1". 1/8" beveled inside edge. Miter corners and silver solder all joints. Mount to aluminum frame with screws from back tapped holes.
- Cast bronze prismatic star, mechanically fastened to brass block with concealed mechanical fasteners to prevent removal.
- 4. Four color process plotted vinyl graphic laminated between two layers of 1/8" acrylic. Front layer to be clear non-glare. The back layer to 1/8" clear acrylic. Mount with magnetic or double-sided tape to back panel after mounting frame to wall.
- F1. Clear powder coat finish, horizontal grain (parallel to frame component) and polished finish on the bevel and return.
- F2. Clear powder coat finish.



REVISIONS:

DESCRIPTION DATE

OWNER

Architect of the Capitol
Architecture Division Room H2-529
Ford House Office Bldg.
2nd. and D Streets S.W.
Washington, D.C. 20024
TEL: 202-226-1820 FAX: 202-226-1981

ENVIRONMENTAL GRAPHIC DESIGNER

The Douglas|Group 915 Duke Street Alexandria, VA 22202 TEL: 703-549-8050 FAX: 703-549-8053

DESIGN INTENT DRAWINGS FOR SUPERINTENDENT APPROVAL

APPROVAL:

LARRY STOFFELL SUPERINTENDENT SENATE OFFICE BUILDINGS

SIGNATURE

BUILDING NAME
HART SENATE OFFICE BUILDING

CAPITOL COMPLEX - WAYFINDING & ADA COMPLIANCE

DRAWING TITLE

PROJECT TITLE

D,E,G,W & HH - Assembly Option

SCALE DRAWN BY CHECKED BY
SH/MB
PROJ. NO. IFB NO.

24512.02 CAD FILE NO.

ASSEMBLY

SHEET DAT

06/14/06